SACKLEY RESIDENCE

4122 THE STRAND, MANHATTAN BEACH, CA 90266

GENERAL NOTES

BUILDING COMPLIES WITH 2022 CBC, 2022 CMC, 2022 CPC, 2022 CEC, AND CITY OF MANHATTAN BEACH.

AQMD NOTIFICATION IS REQUIRED 10 DAYS BEFORE BEGINNING ANY DEMOLITION WORK. REQUIRED FORM IS AVAILABLE AT THE COMMUNITY DEVELOPMENT DEPARTMENT. PROVIDE PROOF OF NOTIFICATION (MAIL WITH RETURN RECEIPT) 10 DAYS BEFORE BUILDING PERMIT IS ISSUED, OR COMPLETE ASBESTOS

3. ALL BUILDING FEATURES PROJECTING INTO REQUIRED SETBACKS ARE INDICATED ON SITE/PLOT PLAN.

. SOILS REPORT SHALL BE PROVIDED TO THE BUILDING DEPARTMENT FOR ALL CUTS, FILLS, AND EARTHWORK AS REQUIRED BY SECTION 1804.1-1804.4 UBC. - SEE SP-02

STUMPS AND ROOTS SHALL BE REMOVED TO A DEPTH OF 12" IN THE AREA OCCUPIED BY THE BUILDING.

INSTALLATION OF INTERIOR AND EXTERIOR WALL AND CEILING COVERINGS SHALL CONFORM TO CHAPTER 25 UBC.

ALL WATER CLOSETS TO FLUSH WITH 1.28 GALLON MAX. (CPC 402.1, 402.2)

8. ALL HOSE BIBS MUST BE PROTECTED BY BACK FLOW PREVENTION

AND HAVE AN ANTI-SIPHON DEVICE. PROVIDE APPROVED BACKWATER VALVE FOR ALL PLUMBING FIXTURES LOCATED BELOW THE ELEVATION OF THE NEXT UPSTREAM MANHOLE COVER. FIXTURES ABOVE SUCH ELEVATION SHALL NOT

WASTE PIPE RISERS. (UPC 710.1) 10. ALL WINDOW COVERINGS REQUIRED BY CFIR, FORM SHALL BE POSTED PRIOR TO FINAL INSPECTION.

DISCHARGE THROUGH THE BACKWATER VALVE. PROVIDE CAST IRON

11. WRITTEN APPROVAL FROM THE SOUTH COAST AIR QUALITY MANAGEMENT DISTRICT (SCAQMD). (714)396:2000 PER RULE 1403 FOR THE PROPER DISPOSAL OF ASBESTOS.

12. ONLY LOS ANGELES COUNTY HEALTH DEPARTMENT APPROVED DEVICES MAY BE UTILIZED FOR LANDSCAPE IRRIGATION BACK FLOW

13. ALL SITE DRAINAGE SHALL BE TERMINATED AT PUBLIC WAY VIA NON-EROSIVE DEVICE PER MBMC.

14. PROVIDE DRIP PAN OR SIMILAR DEVICE FOR LAUNDRY ROOM, WATER HEATER, AND DISHWASHER. 15. PROVIDE SURVEY STAKES PRIOR TO FOUNDATION INSPECTION TO

16. THE ARCHITECT IS NOT RESPONSIBLE FOR SITE GRADING OR

17. IAPMO APPROVAL REQUIRED FOR ONE PIECE LAVATORY.

18. POST INSULATION COMPLIANCE CARD IN CONSPICUOUS LOCATION IN DWELLING PRIOR TO FINAL INSPECTION.

IT IS THE GENERAL CONTRACTORS RESPONSIBILITY TO VERIFY THAT THE BUILDING IS WITHIN THE HEIGHT LIMIT PRIOR TO FRAMING

THE ROOF RAFTERS. CONTACT THE CIVIL SURVEY CONSULTANTS. 20. CONTROL VALVE FOR SHOWERS AND TUB/SHOWERS SHALL BE OF THE PRESSURE BALANCE OR THERMOSTATIC MIXING VALVE TYPE. UPC.

21. VERIFY CLEARANCES WITH OVERHEAD UTILITY LINES FROM ALL PERMANENT AND TEMPORARY STRUCTURE INCLUDING SCAFFOLDING AND OTHER WORKING AREAS DURING CONSTRUCTION. CLEARANCE TO BE 8 F. HORIZONTAL AND 12 FT. VERTICAL. VERIFY WITH SOUTHERN CALIFORNIA EDISON CO. BEFORE COMMENCING CONSTRUCTION.

22. PROVIDE PROTECTION TO PEDESTRIANS PER UBC SECTION 3303 DURING CONSTRUCTION.

23. BUILDING ADDRESS SHALL BE PROVIDED ON THE BUILDING IN SUCH A POSITION AS TO BE PLAINLY VISIBLE AND LEGIBLE FROM THE STREET. ADDRESS NUMBERS SHALL CONTRAST WITH THEIR BACKGROUND, 4" HIGH MINIMUM AND WITH A MINIMUM STROKE WIDTH OF 0.5" - PER SECTION R319.1

24. N/A

DRAINAGE.

25. COOKING EQUIPMENT MUST BE LISTED FOR RESIDENTIAL USE.

26. THE JURISDICTION HAVING AUTHORITY SHALL BE NOTIFIED IN WRITING OF ANY CHANGES. THE REGISTERED DESIGN PROFESSIONAL SHALL REVIEW AND COORDINATE ALL SUBMITTED DOCUMENTS PREPARED BY OTHERS, INCLUDING DEFERRED SUBMITTAL ITEMS. THE REGISTERED DESIGN PROFESSIONAL SHALL SUBMIT DEFERRED DOCUMENTS TO THE JURISDICTION HAVING AUTHORITY IN A TIMELY MANNER. THE OWNER SHALL NOTIFY THE BUILDING OFFICIAL IN WRITING IF THE REGISTERED DESIGN PROFESSIONAL IN RESPONSIBLE CHARGE IS CHANGED.

ELECTRICAL. MECHANICAL SYSTEMS AND SHALL HAVE PRIOR APPROVAL OF THE BUILDING OFFICIAL.

27. DEFERRED SUBMITTAL DOCUMENTS FOR FIRE SPRINKLERS

28. OBTAIN SANITATION DISTRICT APPROVAL FOR ANY NEW SEWER

29. CHECK CITY RECORDS TO DETERMINE EXISTENCE OF CESSPOOL ON PROPERTY. ANY EXISTING CESSPOOL SHALL BE LOCATED AND INSPECTED BY CITY PERSONNEL BEFORE DEMOLITION OR BUILDING

30. PENETRATIONS THROUGH FIRE RATED FLOORS AND WALLS SHALL COMPLY WITH SECTION R302.4.

PUBLIC WORKS NOTES

1. ALL LANDSCAPE IRRIGATION BACKFLOW DEVICES MUST MEET CURRENT CITY REQUIREMENTS FOR PROPER INSTALLATION.

NO DISCHARGE OF CONSTRUCTION WASTEWATER, BUILDING MATERIALS, DEBRIS, OR SEDIMENT FROM THE SITE IS PERMITTED. NO REFUSE OF ANY KIND GENERATED ON A CONSTRUCTION SITE MAY BE DEPOSITED IN RESIDENTIAL COMMERCIAL, OR PUBLIC REFUSE CONTAINERS AT ANY TIME. THE UTILIZATION OF WEEKLY REFUSE COLLECTION SERVICE BY THE CITY'S HAULER FOR ANY REFUSE GENERATED AT THE CONSTRUCTION SITE IS STRICTLY PROHIBITED. FULL DOCUMENTATION OF ALL MATERIALS/TRASH LANDFILLED AND RECYCLED MUST BE SUBMITTED TO THE PERMITS DIVISION IN COMPLIANCE OF THE CITY'S CONSTRUCTION AND DEMOLITION RECYCLING ORDINANCE.

EROSION AND SEDIMENT CONTROL DEVISED BMPS (BEST MANAGEMENT PRACTICES) MUST BE IMPLEMENTED AROUND THE CONSTRUCTION SITE TO PREVENT DISCHARGES TO THE STREET AND ADJACENT PROPERTIES. BMPS MUST BE IDENTIFIED AND SHOWN ON THE PLAN. CONTROL MEASURES MUST ALSO BE TAKEN TO PREVENT STREET SURFACE WATER ENTERING THE SITE.

4. ALL STORM WATER, NUISANCE WATER, ETC. DRAIN LINES INSTALLED WITHIN THE STREET RIGHT OF WAY MUST BE CONSTRUCTED OF 3" CAST IRON PIPE AND LABELED ON THE SITE PLAN. DRAIN LINES MUST BE SHOWN ON THE PLANS CONNECTING ON-SITE DRAINAGE LINE TO SEWER LATERAL IS STRICTLY PROHIBITED.

5. ALL CONCENTRATED RUNOFF WATER FROM THE ROOF AND SIDE YARDS AND PATIOS MUST DISCHARGE ONTO 42ND STREET THROUGH THE DRAIN LINES AND MUST BE SHOWN ON THE PLANS WITH ALL REQUIRED OUTLET FLOW LINE FLEVATIONS AT THE DISCHARGE POINT

6. IMPERVIOUS SURFACE SHALL BE SLOPED AWAY FROM THE BUILDING AT 2% MINIMUM SLOPE FOR A MINIMUM DISTANCE OF 10 FEET; LOT SHALL BE GRADED TO DRAIN SURFACE WATER AWAY FROM FOUNDATION WALLS - PER C.R.C. SECTION

7. SIDEWALK, DRIVEWAY, CURB, AND GUTTER REPAIRS OR REPLACEMENT MUST BE COMPLETED PER PUBLIC WORKS SPECIFICATIONS. SEE CITY STANDARD PLANS ST-1, ST-2, ST-3 AND ST-10. THE PLANS MUST HAVE A PROFILE OF THE DRIVEWAY, PERCENTAGE (%) OF SLOPE ON DRIVEWAY, AND DRIVEWAY ELEVATIONS FOR EACH SIDE AND THE MIDDLE. IN THE CASE WHERE THE GARAGE LEVEL IS BELOW THE STREET DRAINAGE FLOW LINES, THE COMBINED SLOPE OF PUBLIC AND PRIVATE APPROACH SHALL NOT EXCEED 15% (CITY RECOMMENDS THAT GARAGE FINISH FLOOR ELEVATION PER DESIGN PLANS BE HIGHER THAN EXISTING STREET GRADES, IN ORDER TO MINIMIZE POSSIBILITY OF ANY FUTURE FLOODING IN THE GARAGE). CITY PLANS/SURVEY MUST SHOW ELEVATIONS FOR EACH ADJOINING PROPERTY. NO DEVIATIONS IN ELEVATIONS BETWEEN PROPERTIES SHALL EXCEED MORE THAN 1/4".

8. DRIVEWAY PROFILES EXCEEDING 10% GRADE WILL BE STAKED AND VERIFIED BY LICENSED PROFESSIONAL LAND SURVEYOR. VERIFICATION OF DRIVEWAY GRADES WILL BE DONE PRIOR TO POURING THE GARAGE SLAB. DRIVEWAY GRADES EXCEEDING 15% ARE NOT PERMITTED.

THE BACK OF DRIVEWAY APPROACH MUST BE SIX INCHES HIGHER THAN THE FLOW LINE ON THE STREET. M.B.M.C. 9.76.030. THE DRIVEWAY APRON ON BAYVIEW DRIVE MUST BE IMPROVED PER CITY STANDARD PLANS.

10. CONTRACTOR TO PROTECT IN PLACE ALL EXISTING PROPERTY CORNERS DURING CONSTRUCTION. IF ANY OF THE PROPERTY CORNERS ARE REMOVED OR DESTROYED DURING CONSTRUCTION, IT WOULD BE THE RESPONSIBILITY OF THE CONTRACTOR TO RESTORE THEM.

11. ALL EXISTING OR CONSTRUCTION RELATED DAMAGES OR DISPLACED AND SHOWN ON THE PLANS. ADDITIONAL PUBLIC IMPROVEMENTS MAY BE REQUIRED DURING AND/OR NEAR THE COMPLETION OF CONSTRUCTION PER MBMC 9.72 AS DETERMINED BY THE PUBLIC WORKS INSPECTOR BASED ON CONDITIONS OF PUBLIC

12. IT IS THE RESPONSIBILITY OF THE CONTRACTOR TO PROTECT ALL THE STREET SIGNS, STREET LAMPS/LIGHTS, WALLS/FENCES, AND/OR TREES AROUND THE PROPERTY. IF THEY ARE DAMAGED, LOST OR REMOVED, IT IS THE RESPONSIBILITY OF THE CONTRACTOR TO REPLACE THEM AT THE CONTRACTOR'S EXPENSE. CONTACT THE PUBLIC WORKS INSPECTOR FOR SIGN SPECIFICATION AND SUPPLIERS.

13. NEW 6" VCP SEWER LATERAL WILL BE INSTALLED IF THE EXISTING LATERAL IS LESS THAN 6" IN DIAMETER. SEWER CLEANOUT SHOULD BE LOCATED WITHIN PRIVATE PROPERTY LINES. A BACKWATER VALVE IS REQUIRED ON THE SANITARY SEWER LATERAL IF THE DISCHARGES FROM FIXTURES WITH FLOOD LEVEL RIMS ARE LOCATED BELOW THE NEXT UPSTREAM MANHOLE COVER OF THE PUBLIC SEWER (PER CITY STANDARD PLAN ST-24).

14. IF ANY EXISTING SEWER LATERAL (6" MINIMUM) IS USED, IT MUST BE TELEVISED TO CHECK ITS STRUCTURAL INTEGRITY PRIOR TO ANY DEMOLITION WORK. THE TAPE MUST BE MADE AVAILABLE FOR REVIEW BY THE PUBLIC WORKS DEPARTMENT AND MUST SHOW PROOF OF THE LOCATION OF WHERE IT WAS SHOT. THE PUBLIC WORKS DEPARTMENT WILL REVIEW THE TAPE AND DETERMINE AT THAT TIME IF THE SANITARY SEWER LATERAL NEEDS REPAIRING, REPLACEMENT, OR THAT IT IS STRUCTURALLY SOUND AND CAN BE USED IN IT PRESENT CONDITION. VIDEOING OF LATERAL MUST BE IN ITS ORIGINAL STATE. NO CLEANING, FLUSHING OR ALTERING PRIOR TO VIDEOING IS PERMITTED.

15. IF A NEW SEWER LATERAL IS TO BE INSTALLED AT A DIFFERENT LOCATION ON THE SEWER MAIN LINE, THE OLD LATERAL MUST BE CAPPED AT THE PROPERTY LINE AND AT THE MAIN LINE. PRIOR TO STRUCTURE DEMOLITION A SEWER CAP VERIFICATION AND APPROVAL FROM PUBLIC WORKS INSPECTOR IS REQUIRED.

16. WATER METERS MUST REMAIN ACCESSIBLE FOR METER READERS DURING CONSTRUCTION. WATER METERS SHALL BE PLACED NEAR THE PROPERTY LINE AND OUT OF THE DRIVEWAY APPROACH WHENEVER POSSIBLE. WATER METER PLACEMENT MUST BE SHOWN ON THE PLANS. SEE CITY STANDARD PLAN ST-15. FOR EXISTING WATER SERVICE RELOCATIONS AND/OR ABANDONMENT, WATER SERVICE MUST BE CAPPED AT THE MAIN AND AT THE METER.

17. THE WATER METER BOX MUST BE PURCHASED FROM THE CITY, AND MUST HAVE A TRAFFIC RATED LID IF THE BOX IS LOCATED IN THE DRIVEWAY.

18. EACH PROPERTY MUST PROVIDE A SEPARATE SEWER LATERAL PER

M.B.M.C.5.36 AND SEPARATE WATER SERVICE PER CITY STANDARD PLAN ST-15. 19. RESIDENTIAL PROPERTIES MUST PROVIDE AN ENCLOSED STORAGE AREA FOR REFUSE CONTAINERS. THESE AREAS MUST BE CONSTRUCTED TO MEET THE

REQUIREMENTS OF M.B.M.C. 5.24.030. THE AREA MUST BE SHOWN IN DETAIL ON THE PLANS BEFORE A PERMIT IS ISSUED. 20. ALL WORK DONE WITHIN THE PUBLIC RIGHT-OF-WAY SHALL BE DONE BY A LICENSED CONTRACTOR WITH A CLASS A C-12 OR C-34 LICENSE FOR ALL

TRENCHING AND PAVING OR A CLASS C-08 LICENSE FOR ALL CONCRETE WORK. A CLASS B LICENSE MAY BE ACCEPTABLE FOR MINOR CURB, GUTTER AND SIDEWALK WORK CONSTRUCTED IN CONJUNCTION WITH A SINGLE-FAMILY RESIDENTIAL STRUCTURE. A SEPARATE PERMIT IS REQUIRED FOR WORK IN THE PUBLIC RIGHT OF

21. PLAN HOLDER MUST HAVE THE PLANS RECHECKED AND STAMPED FOR APPROVAL BY THE PUBLIC WORKS DEPARTMENT BEFORE THE BUILDING PERMIT IS

22. THE CONTRACTOR SHALL MONITOR, SUPERVISE AND CONTROL ALL CONSTRUCTION AND CONSTRUCTION SUPPORTIVE ACTIVITIES, SO AS TO PREVENT THESE ACTIVITIES FROM CAUSING A PUBLIC NUISANCE, INCLUDING BUT NOT LIMITED TO, ENSURING STRICT ADHERENCE TO THE FOLLOWING: (A) REMOVAL OF DIRT, DEBRIS OR OTHER CONSTRUCTION MATERIAL DEPOSITED ON ANY PUBLIC STREET NO LATER THAN THE END OF EACH WORKING DAY. (B) ALL EXCAVATIONS SHALL BE BACKFILLED AT THE END OF EACH WORKING DAY ÀND ROADS OPENED TO VEHICULAR TRAFFIC UNLESS OTHERWISE APPROVED BY THE (C) ALL DUST CONTROL MEASURES PER SOUTH COAST AIR QUALITY MANAGEMENT DISTRICT (SCAQMD) REQUIREMENTS SHALL BE ADHERED TO DURING THE CONSTRUCTION OPERATIONS.

(D) ALL CONSTRUCTION TO BE IN CONFORMANCE WITH THE REGULATIONS OF

PLANNING NOTES

1. ALL BUILDING FEATURES PROJECTING INTO REQUIRED SETBACKS SHALL BE INDICATED ON SITE/PLOT PLAN.

SEPARATE PERMITS AND PLANS ARE REQUIRED FOR SPAS, FIRE SPRINKLER, SHORING, RETAINING WALLS OR BLOCK FENCES POOLS, SOLAR SYSTEMS, DEMOLITION AND SEWER CAP OF EXISTING BUILDINGS. IF SUCH IMPROVEMENTS OR DEMOLITION IS REQUIRED AS A CONDITION OF APPROVAL FOR DISCRETIONARY ACTIONS OR TO COMMENCE BUILDING, THEN SUCH PERMITS MUST BE OBTAINED BEFORE OR AT THE TIME THE PROPOSED BUILDING PERMIT IS ISSUED.

FENCE, WALL, HANDRAIL HEIGHTS, AND HEDGES AS MEASURED FROM THE LOWEST FINISHED GRADE ADJACENT TO EACH SECTION OF THESE STRUCTURES, MAY BE A MAXIMUM OF 42" IN THE FRONT YARD SETBACK, AND 72" AT ALL OTHER LOCATIONS ON SITE. (36" IF IN DRIVEWAY VISIBILITY TRIANGLE AND IN THE TRAFFIC VISION CLEARANCE TRIANGLE).

5. PARKING IS NOT PERMITTED IN REQUIRED YARDS OR OPEN SPACE EXCEPT A 20'

6. A 'CAPPED TEE' FITTING MUST BE INSTALLED OVER THE COLD WATER SUPPLY LINE ABOVE THE WATER HEATER FOR FUTURE SOLAR WATER HEATING. P&T RELIEF VALVE SHALL TERMINATE OUTSIDE THE BUILDING.

7. ROUTE UNDERGROUND CONDUIT TO POWER POLE PER PUBLIC WORKS DEPARTMENT HANDOUT ST-13. STUB OUT TO PROPERTY LINE FOR FUTURE UNDERGROUNDING OF UTILITIES WHEN APPLICABLE

9. GAS AND ELECTRIC METERS MUST CLEAR PROPERTY LINES BY 3'-0".

ON PROPERTY. IF THERE IS AN EXISTING CESSPOOL, IT MUST BE LOCATED AND THEN INSPECTED BY CITY PERSONNEL BEFORE DEMOLITION OR BUILDING PERMITS CAN BE

11. CHIMNEYS MAY EXCEED THE MAXIMUM PERMITTED HEIGHT BY NO MORE THAN 5 FEET. PROVIDED THE LENGTH AND WIDTH OF THE CHIMNEY PORTION EXCEEDING THE HEIGHT LIMIT SHALL NOT EXCEED 3 FEET IN WIDTH AND 5 FEET IN LENGTH.

PARAPETS, SATTELITE ANTENNAE, RAILS, SKYLIGHTS, ROOF EQUIPMENT, MUST BE WITHIN THE MAXIMUM ALLOWABLE HEIGHT LIMIT.

SIDE YARD ADJOINING A STREET SHALL BE PLANTING AREA (MBMC10.12.030(0). 14. A TREE REMOVAL PERMIT OR TREE PROTECTION PLAN IS REQUIRED FOR THE REMOVAL OR PRESERVATION OF TREES WITHIN THE FRONT YARD (RESIDENTIAL ZONES

15. ALL UTILITY AND EQUIPMENT LOCATIONS, INCLUDING FIRE SPRINKLER CHECK VALVES, ELECTRIC AND WATER METERS, UTILITY CABINETS, ETC. AND ANY REQUIRED PROTECTIVE POLES. (NOTE: UBC AND SCE REQUIRE THAT ELECTRIC BOXES MUST PROVIDE 3 FEET CLEAR TO ANY OBSTRUCTION, AND IF LOCATED ADJACENT TO A PARKING AREA PROTECTIVE BARRIERS 3 FEET AWAY FROM THE BOX IS REQUIRED. PROTECTIVE BARRIERS MAY NOT ENCROACH INTO THE REQUIRED PARKING OR VEHICLE MANEUVERING AREA.)

AGENCY—SIGNED INSURANCE ENDORSEMENT FORM #1 (GENERAL) TO COMMUNITY DEVELOPMENT DEPARTMENT PRIOR TO FINAL INSPECTION

IT SHALL BE THE DUTY OF EVERY PERSON CUTTING OR

MAKING AN EXCAVATION IN OR UPON ANY PUBLIC PLACE. TO

PLACE AND MAINTAIN BARRIERS AND WARNING DEVICES FOR

THE SAFETY OF THE GENERAL PUBLIC. M.B.M.C.17.16.80. IF

OR SIDEWALK, ADEQUATE CROSSINGS SHALL BE MAINTAINED

FOR VEHICLES AND PEDESTRIANS. M.B.M.C.17.16.100.

ANY EXCAVATION IS MADE ACROSS ANY PUBLIC STREET. ALLEY.

SYMBOL LEGEND

100.00' ELEVATION

— SUB FLOOR ELEVATION

LIGHT WEIGHT CONCRETE

- ELEVATION DESIGNATION

SURFACE DESCRIPTION

(ARROW POINTS DOWN SLOPE)

(ARROW POINTS DOWN SLOPE)

ROOF SLOPE DESCRIPTION

WINDOW LETTER DESIGNATION

SKYLIGHT LETTER DESIGNATION

— DOOR NUMBER DESIGNATION

----- NORTH ARROW DESIGNATION

REVISION NUMBER

SECTION NUMBER

- SHEET NUMBER

— TOP/BOTTOM RISER

ABBREVIATION

A.H. ACTUAL HEIGHT

B.O.W. BOTTOM OF WALL

CEILING

CLEAR

COLUMN

DIMENSION

ELEVATION

FROM ABOVE

FINISHED FLOOR ELEV.

CONSULTANTS

DOWN

FIXED

CONC. CONCRETE

CLG.

CLR.

DN.

ELEV.

F.F.E.

FX.

AWNING WINDOW

CRITICAL HEIGHT

CASEMENT WINDOW

DN. O R. @ O" — # OF RISERS UP/DOWN

- EXTENTS OF REVISION

HORZ. HORIZONTAL

LAND. LANDING

HEIGHT

MAXIMUM

MINIMUM

PLINE. PROPERTY LINE

SECT. SECTION

SHT. SHEET

OPERABLE

REQUIRED

SKEWED

SLOPED

T.O.W. TOP OF WALL

S.F.E. SUB FLOOR ELEVATION

LT.WT. LIGHT WEIGHT CONCRETE

HT.

OP.

REQ.

FLOOR ELEVATION

SHEET NUMBER

— SLOPED SURFACE

- FLOW LINE

4. PROVIDE STREET ADDRESS LETTERS AT A MINIMUM 4" INCHES IN HEIGHT @

8. PROVIDE VISUAL SCREENING FOR PROPOSED MECHANICAL EQUIPMENT AND UTILITY METERS (TOP NEED NOT BE SCREENED IF LOCATED ON INTERIOR SIDE OF DWELLING).

CONTRACTOR TO CHECK CITY RECORDS TO DETERMINE EXISTENCE OF CESSPOOL

13. AT LEAST 20% OF ALL VISIBLE PORTIONS OF A REQUIRED FRONT OR CORNER

AREA DISTRICT II, WEST OF SEPULVEDA BOULEVARD-MBMC10.52.120).

16. PROVIDE NOTARIZED OWNER'S ENCROACHMENT PERMIT AGREEMENT AND

PROJECT DATA

SCOPE OF WORK — CEILING HEIGHT - ROOM NAME SUB-FLOOR ELEVATION CONSTRUCT NEW 3974 S.F. MULTI-FAMILY 2 UNIT BUILDING WITH DETACHED STRUCTURE CONTAINING ELEVATION, FINISH SURFACE, OR CHANGE IN WALL PLAN 2 CAR GARAGE AND 586 S.F. ADU

> PROPERTY OWNERS STUART SACKLEY 4180 THE STRAND

> > MANHATTAN BEACH, CA 90266

LEGAL DESCRIPTION LOT 15, BLOCK 4, TRACT NO. 4103

M.B. 46-8 APN: 4137-008-028

OCCUPANCY AND ZONING

OCCUPANCY: R2/U ZONING: RH

CONSTRUCTION TYPE: V-B FULLY SPRINKLERED AREA DISTRICT: IV

NO. OF UNITS: 3 PARKING SPACES: 4

NO. OF STORIES: 3 (MAIN BLDG.), 2 (DETACHED STRUC.)

APPLICABLE CODES

2022 CBC, 2022 CMC, 2022 CPC, 2022 CEC 2022 CGBSC, 2022 CITY OF MANHATTAN BEACH MUNICIPAL CODE, 2022 CA ENERGY CODE TITLE 24 PART 6

1000 S.F.

AREA CALCULATIONS

UNIT A: FIRST FLOOR:

GARAGE LEVEL: 58 S.F. 1060 S.F. SECOND FLOOR: 812 S.F. THIRD FLOOR: TOTAL FLOOR AREA: 2930 S.F. GARAGE AREA: 387 S.F. 101 S.F. STORAGE & MECHANICAL: BALCONIES AND DECKS: 291 S.F. 559 S.F. UNIT B: SECOND FLOOR: THIRD FLOOR: 485 S.F. TOTAL FLOOR AREA: 1044 S.F. GARAGE AREA (DETACHED): 396 S.F. BALCONIES AND DECKS: 135 S.F. 586 S.F. SECOND FLOOR:

BUILDABLE FLOOR AREA LOT SIZE: 33.31' X 105.11' = 3501 S.F. MAX. BFA: 3501 S.F. X 1.7 = 5952 S.F.

PROPOSED: UNIT A: 2930 S.F. 1044 S.F. 586 S.F. ADU: 4560 S.F.

UNIT B: REQUIRED: 1044 S.F. * .15 = 157 S.F.

157 < 220: 220 S.F. MIN. REQUIRED

MAIN BLDG: 102.78'+101.50'+88.94'+86.97' = 380.19'

DETACHED: 102.78'+101.50'+99.90'+101.00' = 405.18'

380.19' / 4 = 95.05' + 30' = 125.05'

405.18' / 4 = 101.30' + 20' = 121.30'

PROPOSED: 446 S.F.

PROPOSED: 392 S.F.

HEIGHT CALCULATIONS

DEFERRED SUBMITTALS

NOT REQUIRED

OPEN SPACE

UNIT A: REQUIRED: 2930 S.F. * .15 = 440 S.F.

CIVIL SURVEY ENGINEER DENN ENGINEERS (310) 542-9433 3914 DEL AMO BLVD, SUITE 921 TORRANCE, CA 90503

STRUCTURAL ENGINEER GARCIA CASTRO & ASSOCIATES (626)325-3531 750 OTAY LAKES RD. #202 CHULA VISTA, CA. 91910

ENERGY CONSULTANT ENERGL024 (818)665-6023 4826 ALLEN COURT EUREKA, CA. 95503

GEO-TECHNICAL ENGINEER NORCAL ENGINEERING (562)799-9469 10641 HUMBOLT STREET LOS ALAMITOS, CA 90720

PROJECT INFORMATION

SHEET INDEX

C-000 CIVIL SURVEY

AREA CALCULATION SHEET

SITE PLAN

SECTIONS

VICINITY MAP

FIRST FLOOR PLAN, GARAGE LEVEL PLAN

SECOND FLOOR PLAN, THIRD FLOOR PLAN


ELEVATIONS A-202 **ELEVATIONS**

A-300

PRINT DATE 12/11/2023

DWG. NAME

SHEET NO.

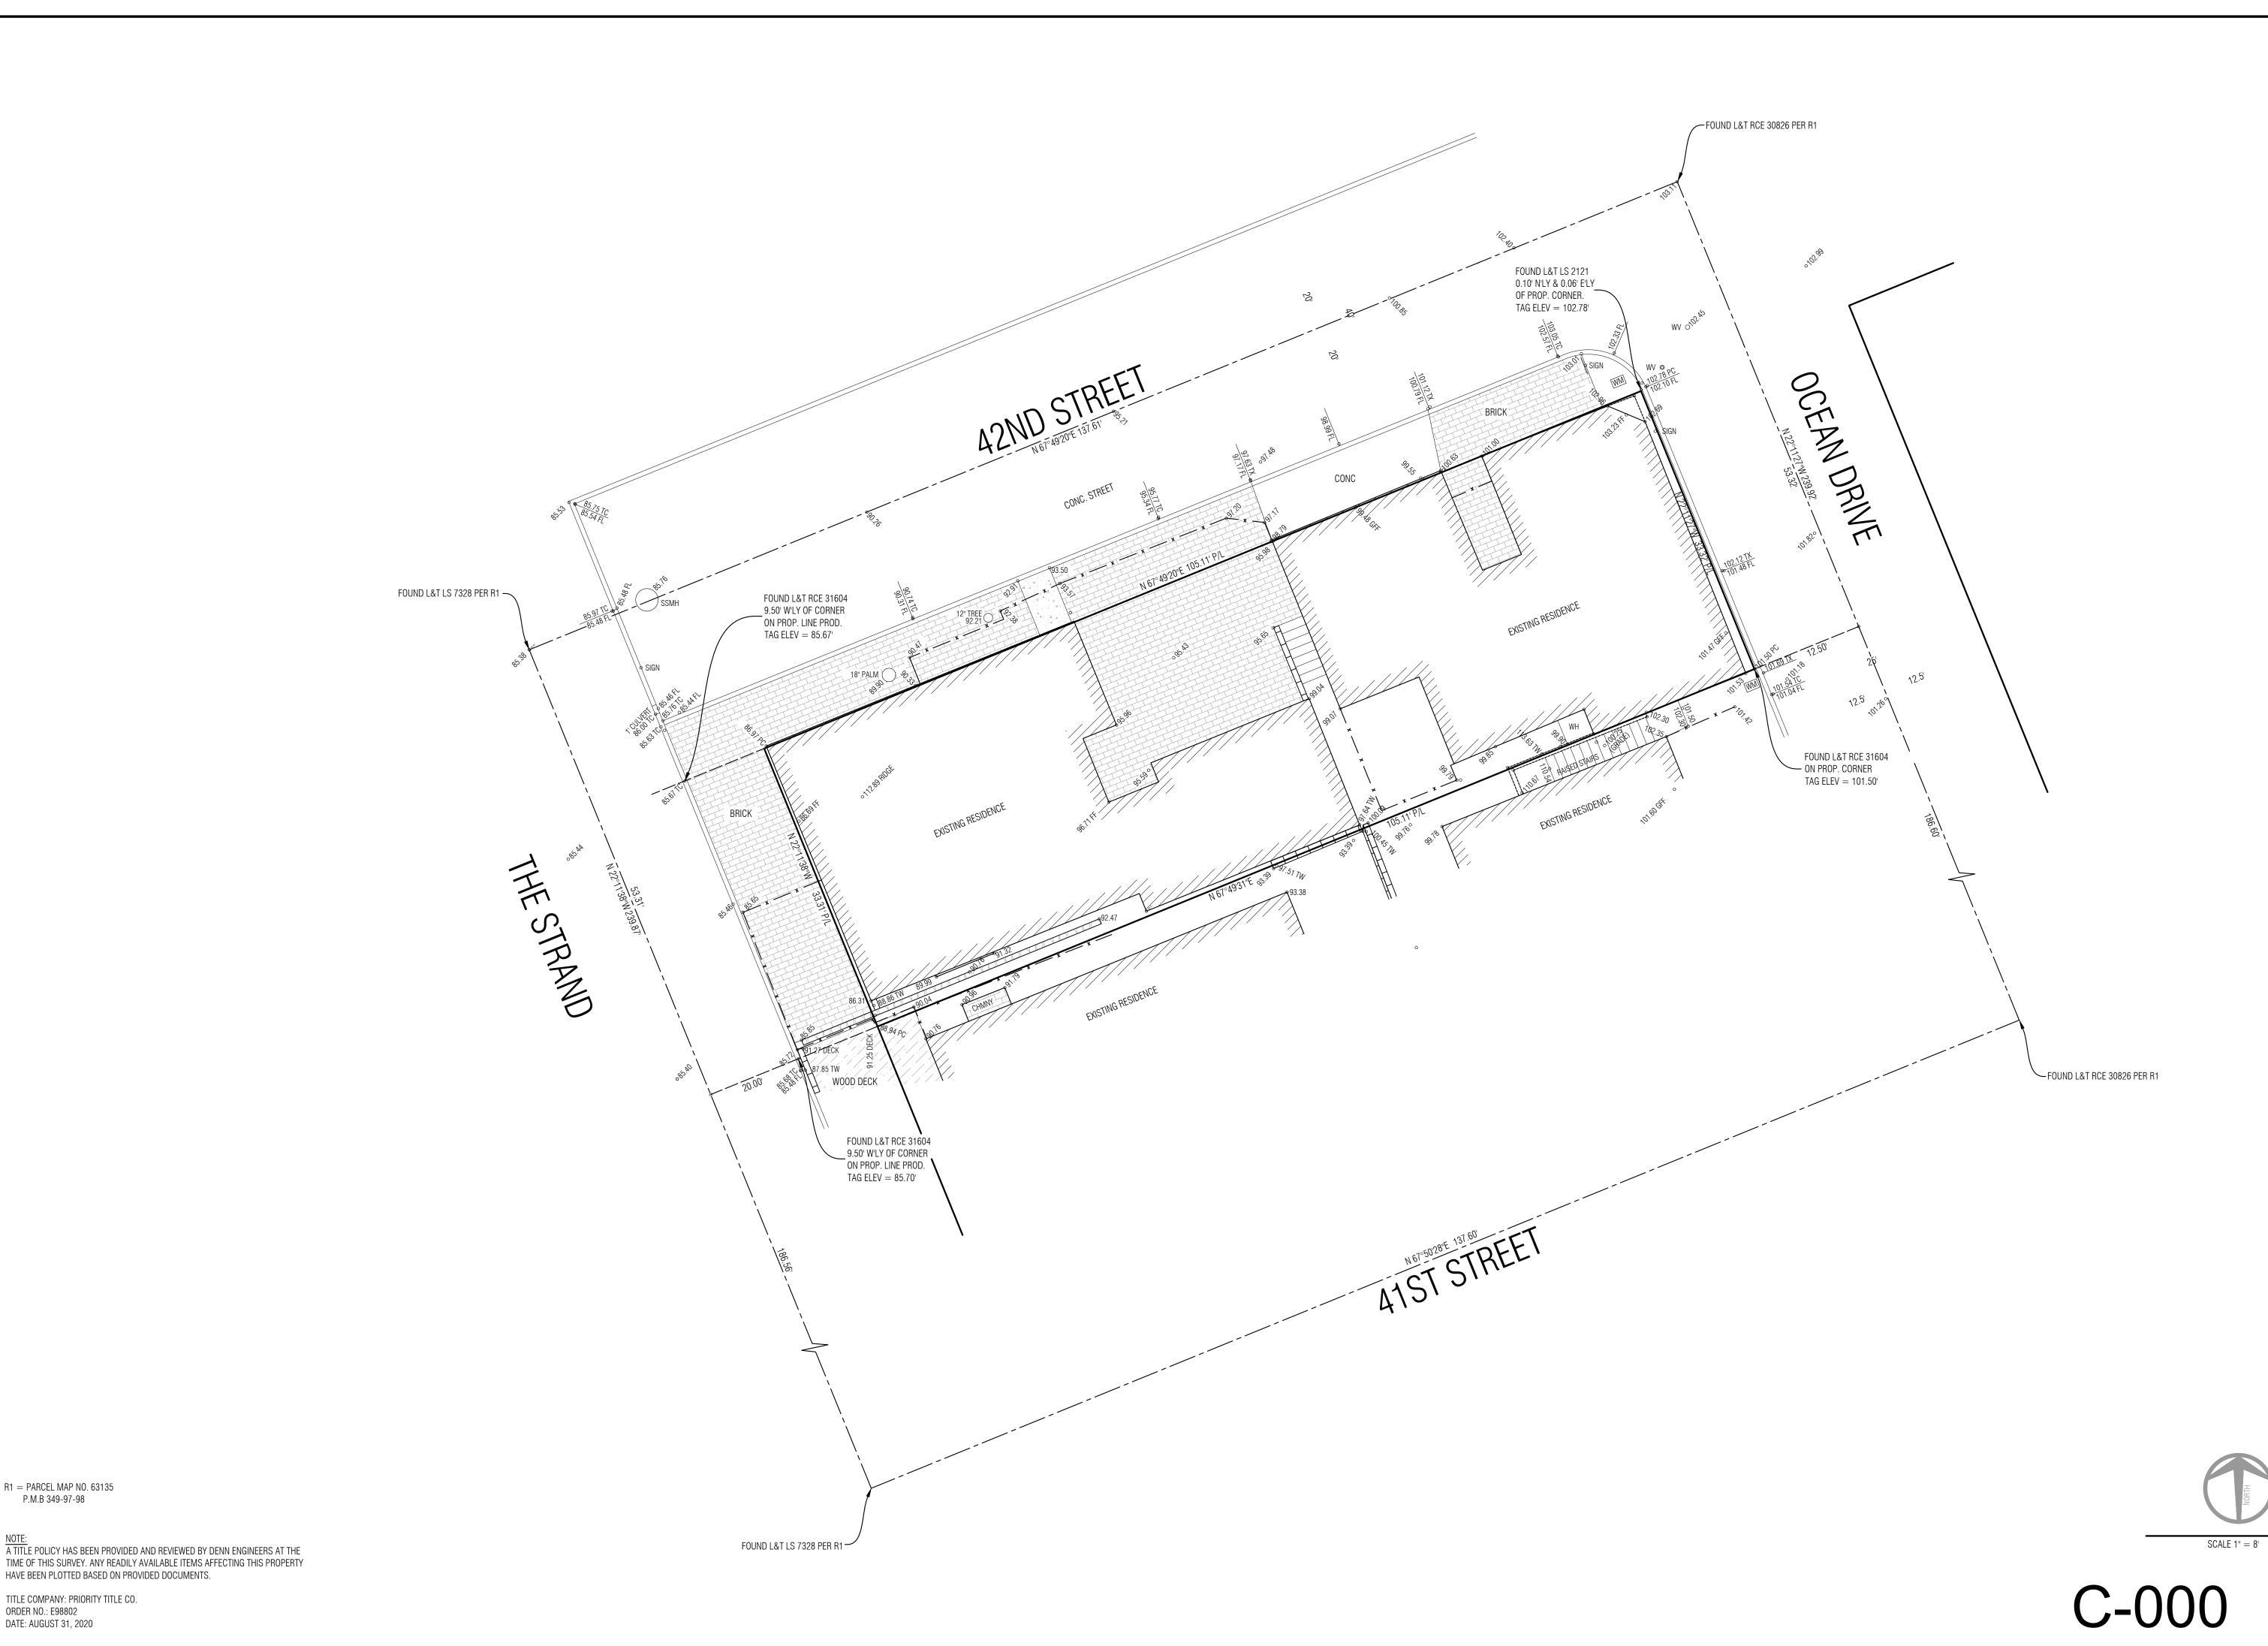

R1 = PARCEL MAP NO. 63135

TITLE COMPANY: PRIORITY TITLE CO.

ORDER NO.: E98802 DATE: AUGUST 31, 2020

P.M.B 349-97-98

3914 DEL AMO BLVD, SUITE 921 TORRANCE, CA 90503 (310) 542-9433

SURVEY AND TOPOGRAPHY

STUART SACKLEY 4180 THE STRAND

MANHATTAN BEACH, CA 90266 PHONE (310) 259-0300

JOB ADDRESS 4122 THE STRAND

MANHATTAN BEACH, CA 90266

LEGAL DESCRIPTION LOT 15, BLOCK 4 TRACT NO. 4103 M.B. 46-8

APN: 4137-008-028

THIS MAP CORRECTLY REPRESENTS A SURVEY MADE BY ME OR UNDER MY DIRECTION IN CONFORMANCE WITH THE REQUIREMENTS OF PROFESSIONAL LAND SURVEYORS' ACT



R.C.E. 30826

LEGEND

BRICK

CONCRETE

∘ 106.76 EXISTING ELEVATION 100 ___ EXISTING CONTOUR BLOCK WALL

— X — EXISTING FENCE BEGINNING OF CURB RETURN CENTERLINE CHAIN-LINK ELECTRIC METER

FOUND FENCE FINISH FLOOR FIRE HYDRANT FLOW LINE GARAGE FINISH FLOOR GAS METER

GUY WIRE LEAD AND TAG NORTHERLY

PROPERTY CORNER / PROP. CORNER PROPERTY LINE / PROP. LINE POWER POLE

SPIKE AND WASHER SOUTHERLY

SANITARY SEWER CLEAN OUT SSMH STK SANITARY SEWER MANHOLE STAKE / STAKE & TAG STREET LIGHT

TOP OF CURB TOP OF WALL / T.O.W. TOP OF DRIVEWAY APRON WESTERLY W'LY


WATER METER NOTE: ALL SETBACK DIMENSIONS SHOWN ARE MEASURED TO EXTERIOR SURFACE OF BUILDINGS UNLESS OTHERWISE NOTED.


BOUNDARY MONUMENTS ARE NOT NECESSARILY SET ON PROPERTY CORNERS. PLEASE REFER TO THE NOTATION ON THE PLANS FOR OFFSET DISTANCES. IF THERE ARE ANY QUESTIONS, PLEASE DO NOT HESITATE TO CONTACT DENN ENGINEERS FOR CLARIFICATION AT: (310) 542-9433, M-F 8:00 AM TO 5:00 PM.

ANY CHANGES OR MODIFICATIONS MADE TO THIS PLAN WITHOUT WRITTEN CONSENT OF DENN ENGINEERS SHALL RELIEVE DENN ENGINEERS FROM ANY LIABILITY OR DAMAGE RESULTING FROM SUCH CHANGES OR MODIFICATIONS, INCLUDING ANY ATTORNEYS FEES OR COSTS INCURRED IN ANY PROCEEDING THAT DENN ENGINEERS MAY BE JOINED.

SHEET 1 OF 1

JOB NO. 20-412B

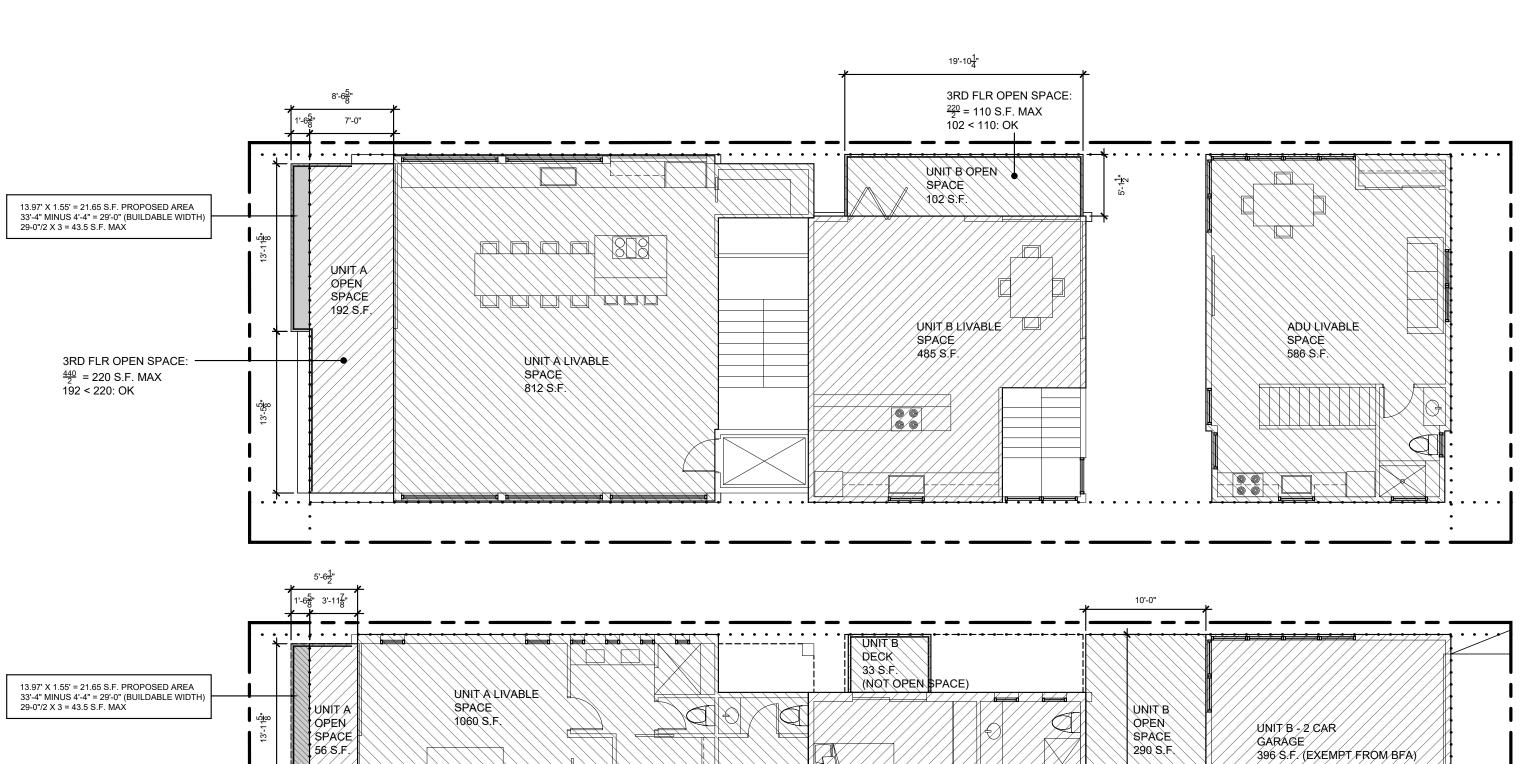


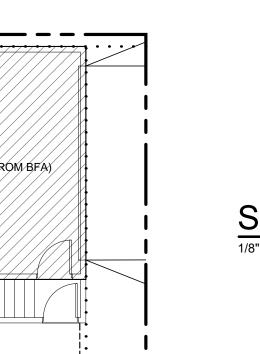

UNIT A ENTRY 58 S.F.		UNIT A	
	UNIT A - 2 CAR GARAGE 387 S.F. (EXEMPT FROM BFA)	STORAGE 101 S.F.	† † † †

/UNIT/B/LIVABLE/

SPACE 559 S.F.

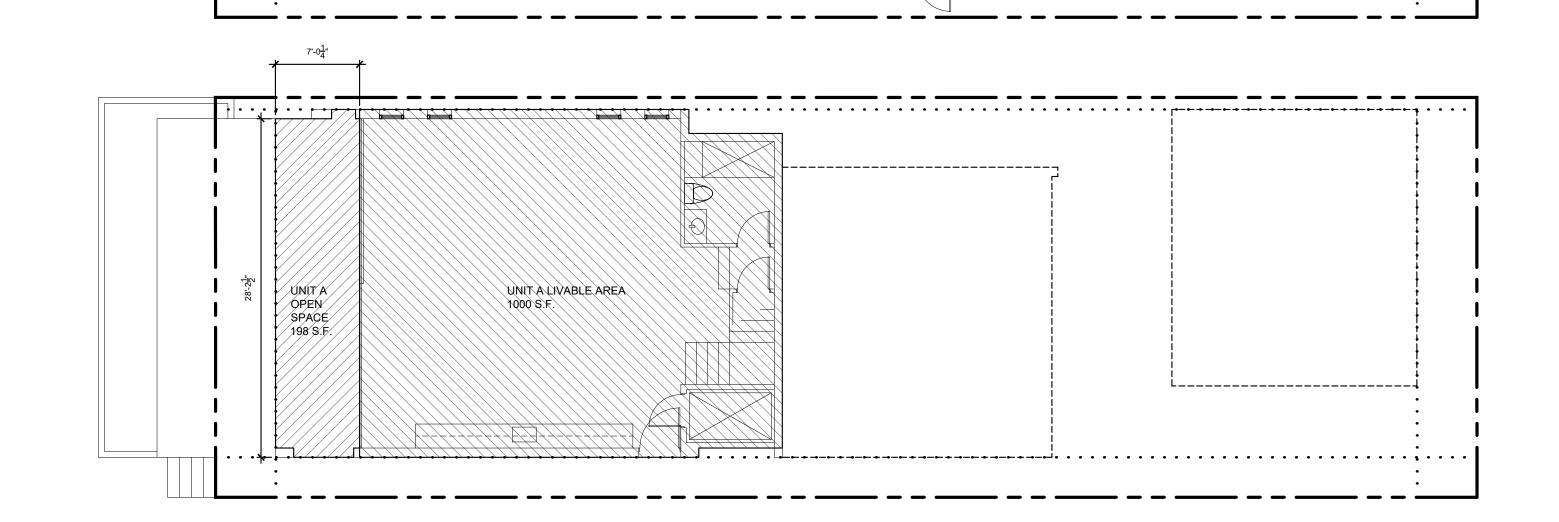

THIRD FLOOR AREA DIAGRAM

	UNIT A	UNIT B	ADU
LIVABLE AREA S.F.	812	485	586
MECH. / STORAGE S.F.	0	0	0
GARAGE S.F.	0	0	0
DECKS S.F.	213.5	102	0
OPEN SPACE S.F.	192	102	0

SECOND FLOOR AREA DIAGRAM

	UNIT A	UNIT B	ADU	
LIVABLE AREA S.F.	1060	559	0	
MECH. / STORAGE S.F.	0	0	0	
GARAGE S.F.	0	396	0	
DECKS S.F.	77.5	33	0	
OPEN SPACE S.F.	56	290	0	


GARAGE LEVEL AREA DIAGRAM 1/8" = 1'-0"

	UNIT A	UNIT B	ADU
IVABLE AREA S.F.	56	0	0
MECH. / STORAGE S.F.	101	0	0
GARAGE S.F.	387	0	0
DECKS S.F.	0	0	0
OPEN SPACE S.F.	0	0	0

FIRST FLOOR AREA DIAGRAM

	UNIT A	UNIT B	ADU
LIVABLE AREA S.F.	1000	0	0
MECH. / STORAGE S.F.	0	0	0
GARAGE S.F.	0	0	0
DECKS S.F.	0	0	0
OPEN SPACE S.F.	198	0	0

DATE

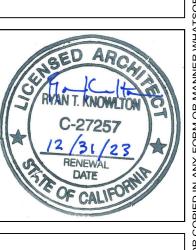


PRINT DATE 12/11/2023

DWG. NAME AREA CALCULATIONS


SHEET NO.

A-101

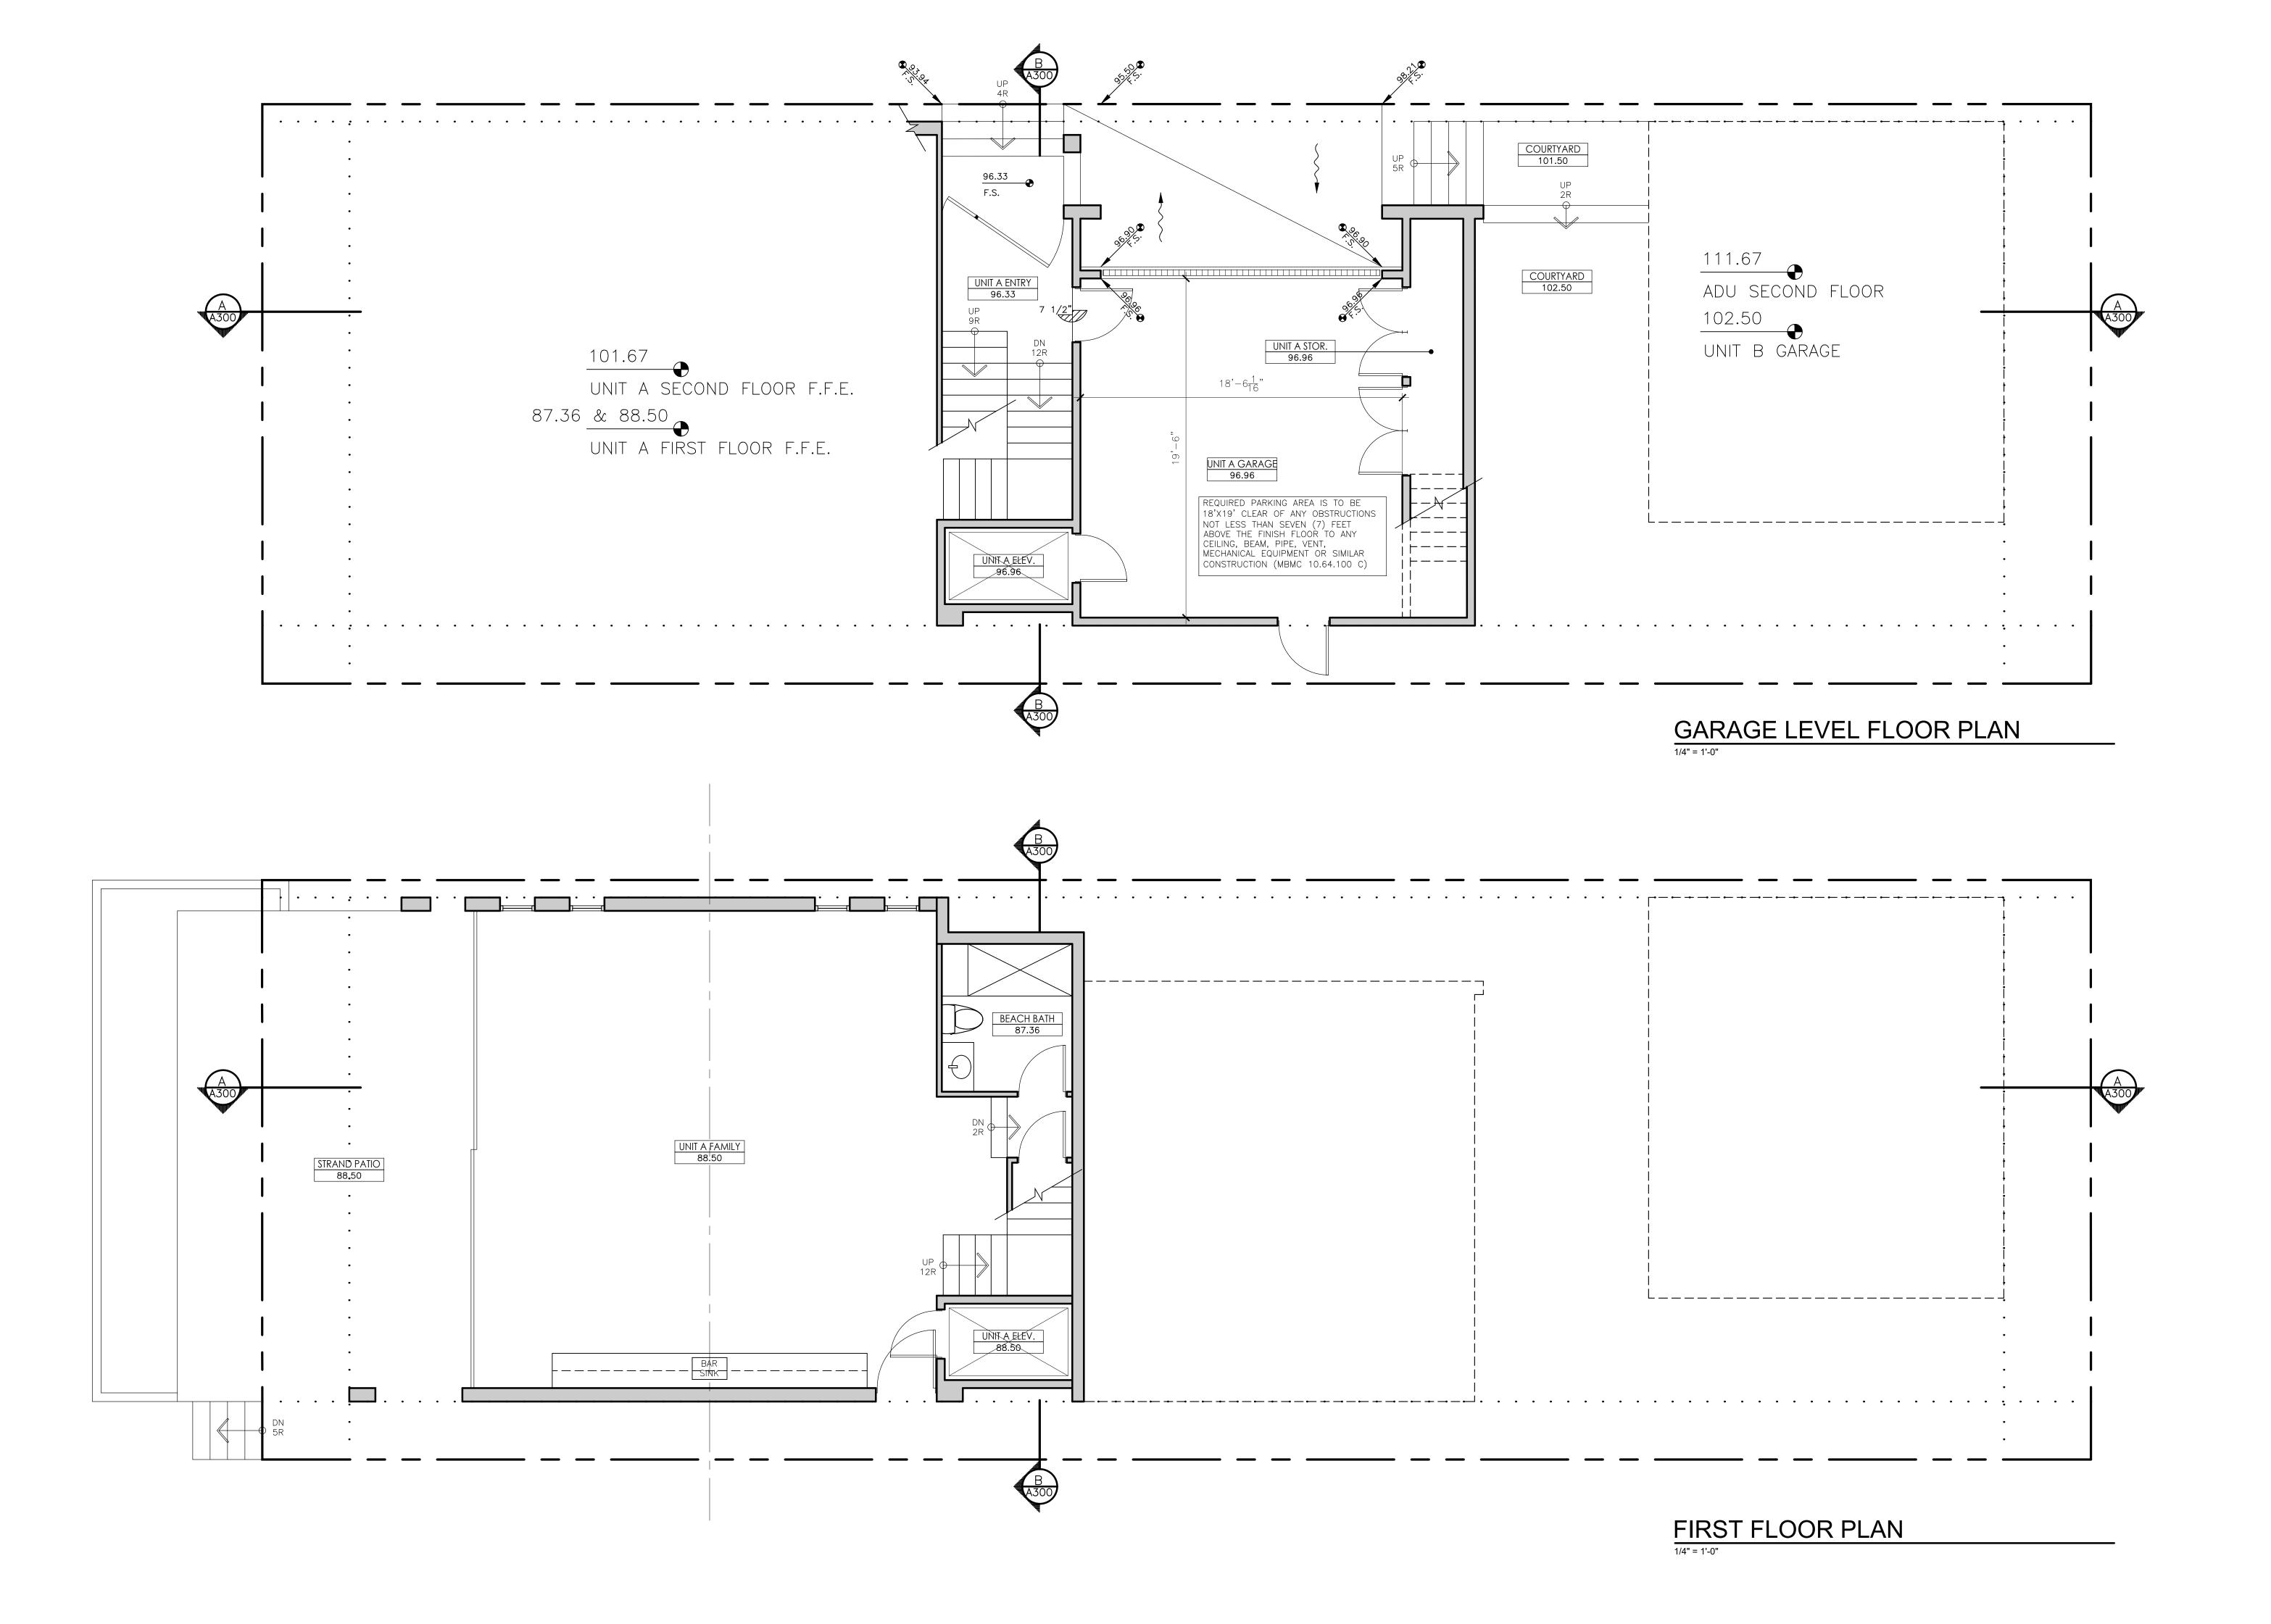

DATE KEV#


HE KNOWLTON GROUP IN STREET, SUITE D, MANHATTAN BEACH

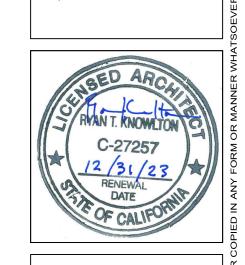

KLEY RESIDENCE

PRINT DATE 12/11/2023

DWG. NAME FIRST FLOOR & GARAGE LEVEL

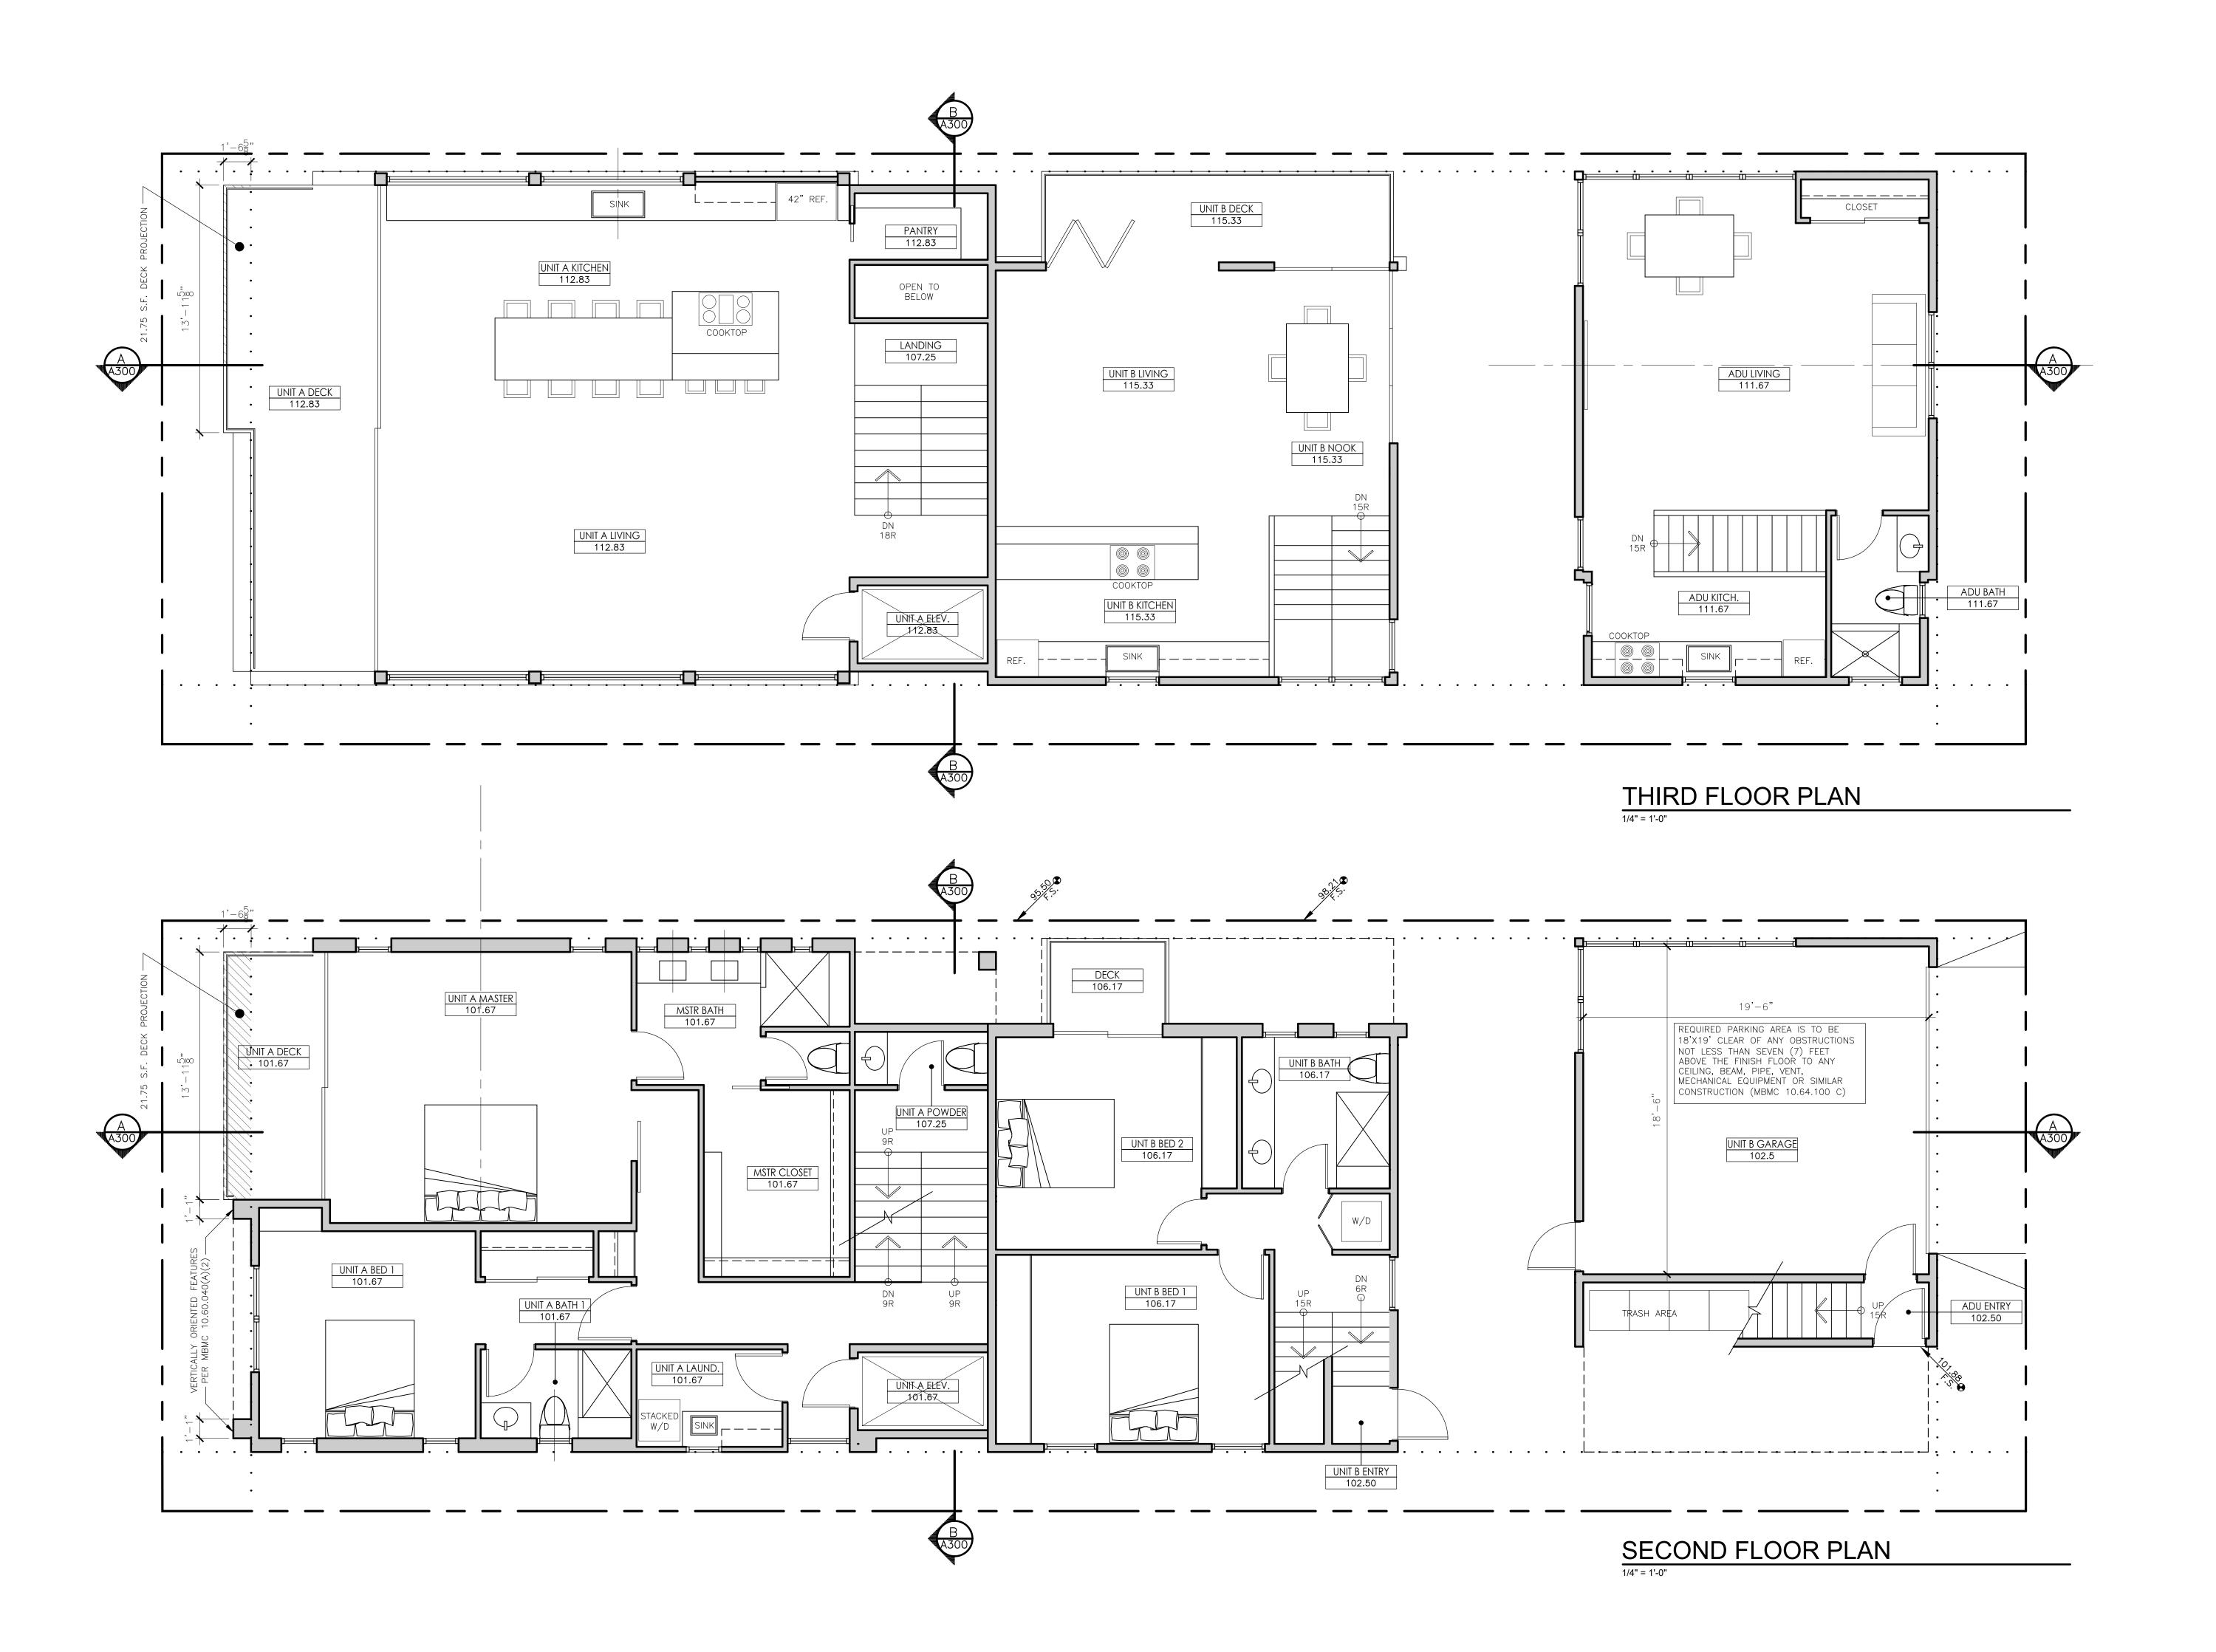

DATE REV#

TE KNOWLTON GROUP STREET, SUITE D, MANHATTAN BEACH


BY STAN T. KNOWLTON COLOR TO THE CONTROL OF CALIFORNIA SANDATE OF

KLEY RESIDENCE

SACKLE

PRINT DATE 12/11/2023

DWG. NAME SECOND & THIRD FLOOR PLANS

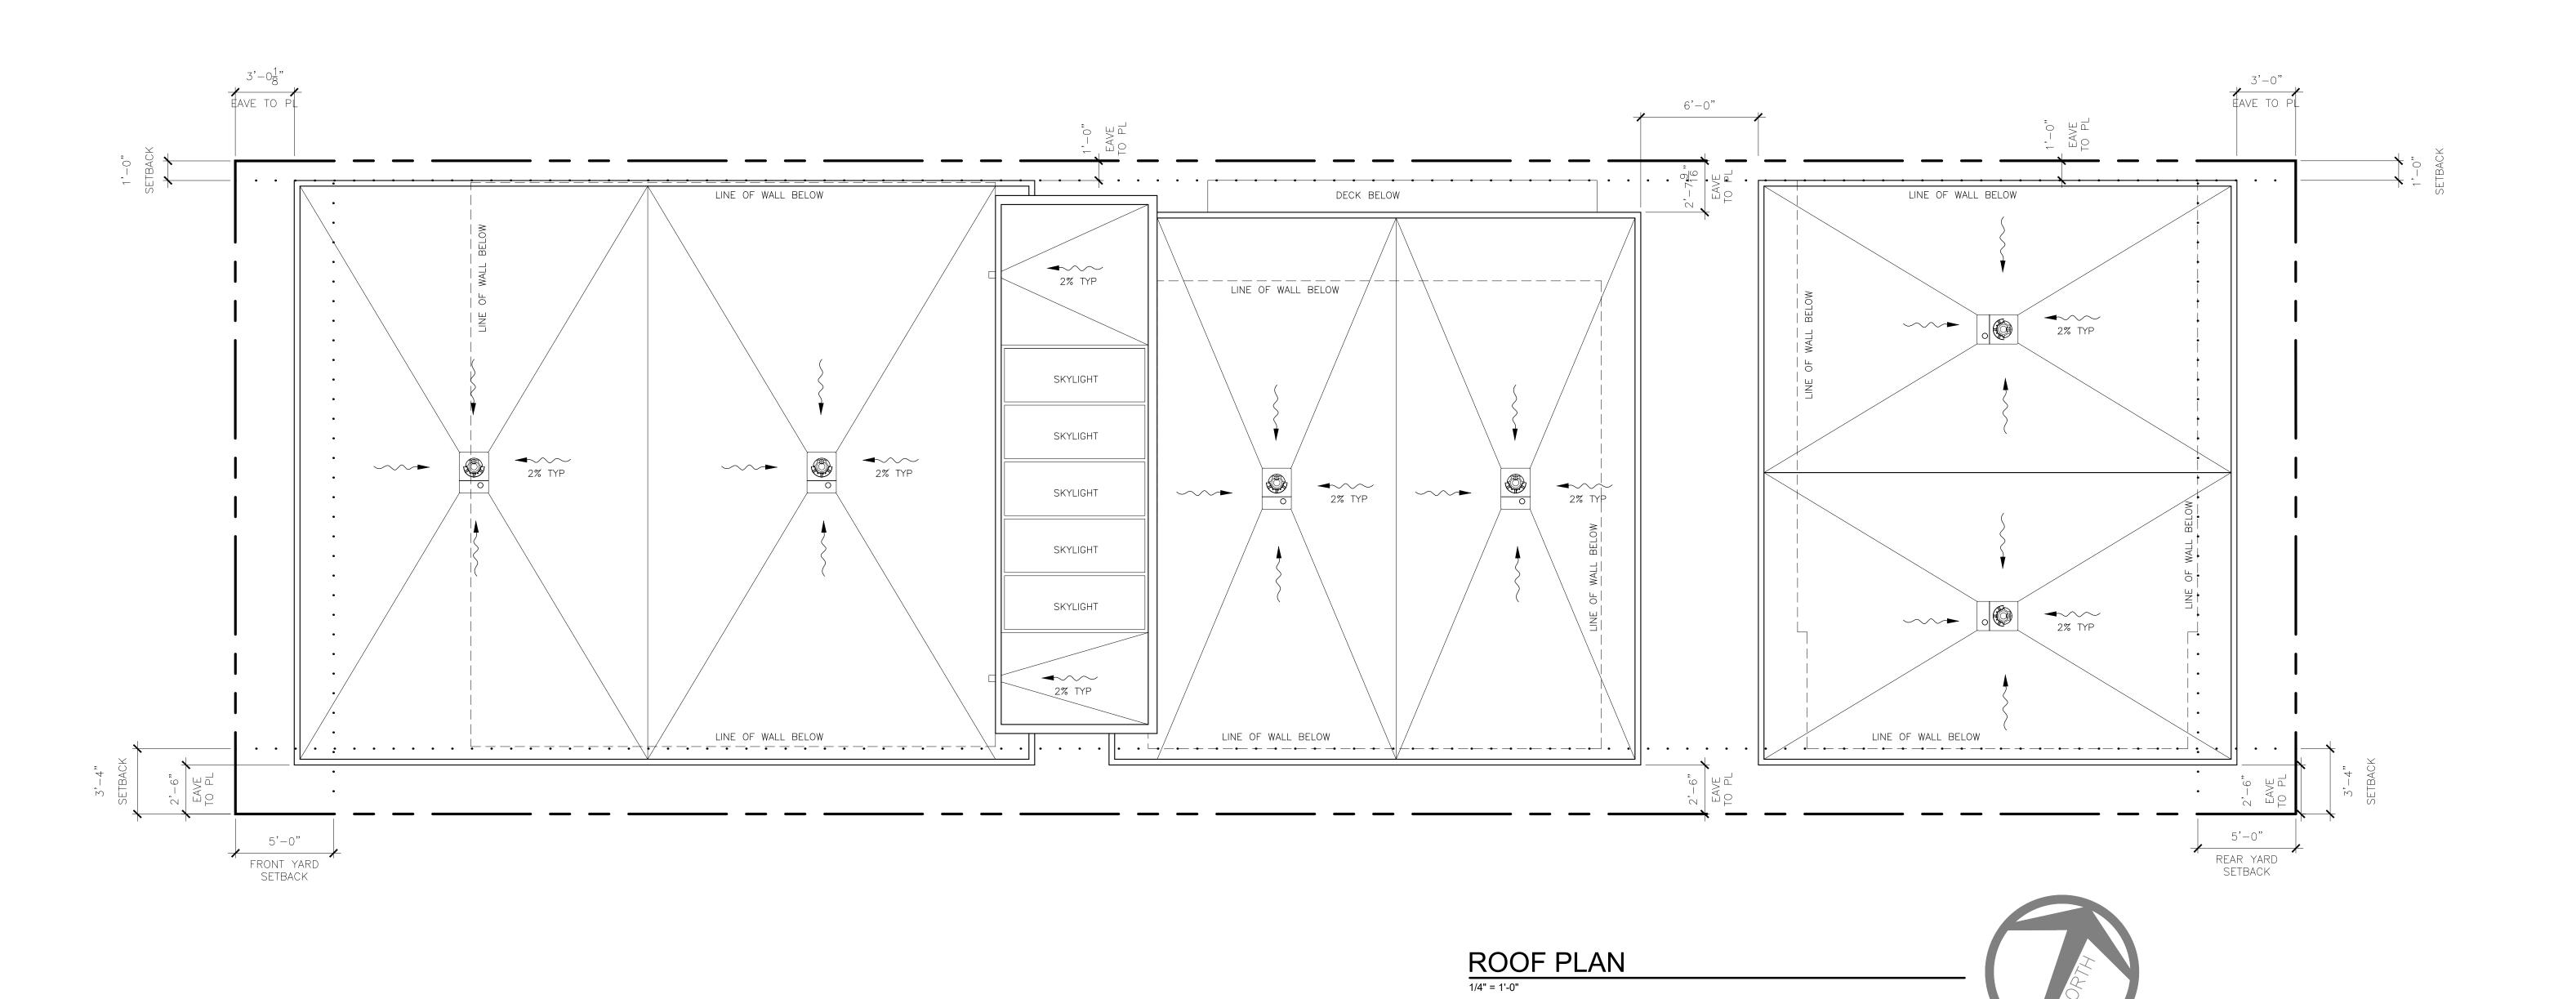



DATE

PRINT DATE

12/11/2023

DWG. NAME **ROOF PLAN**

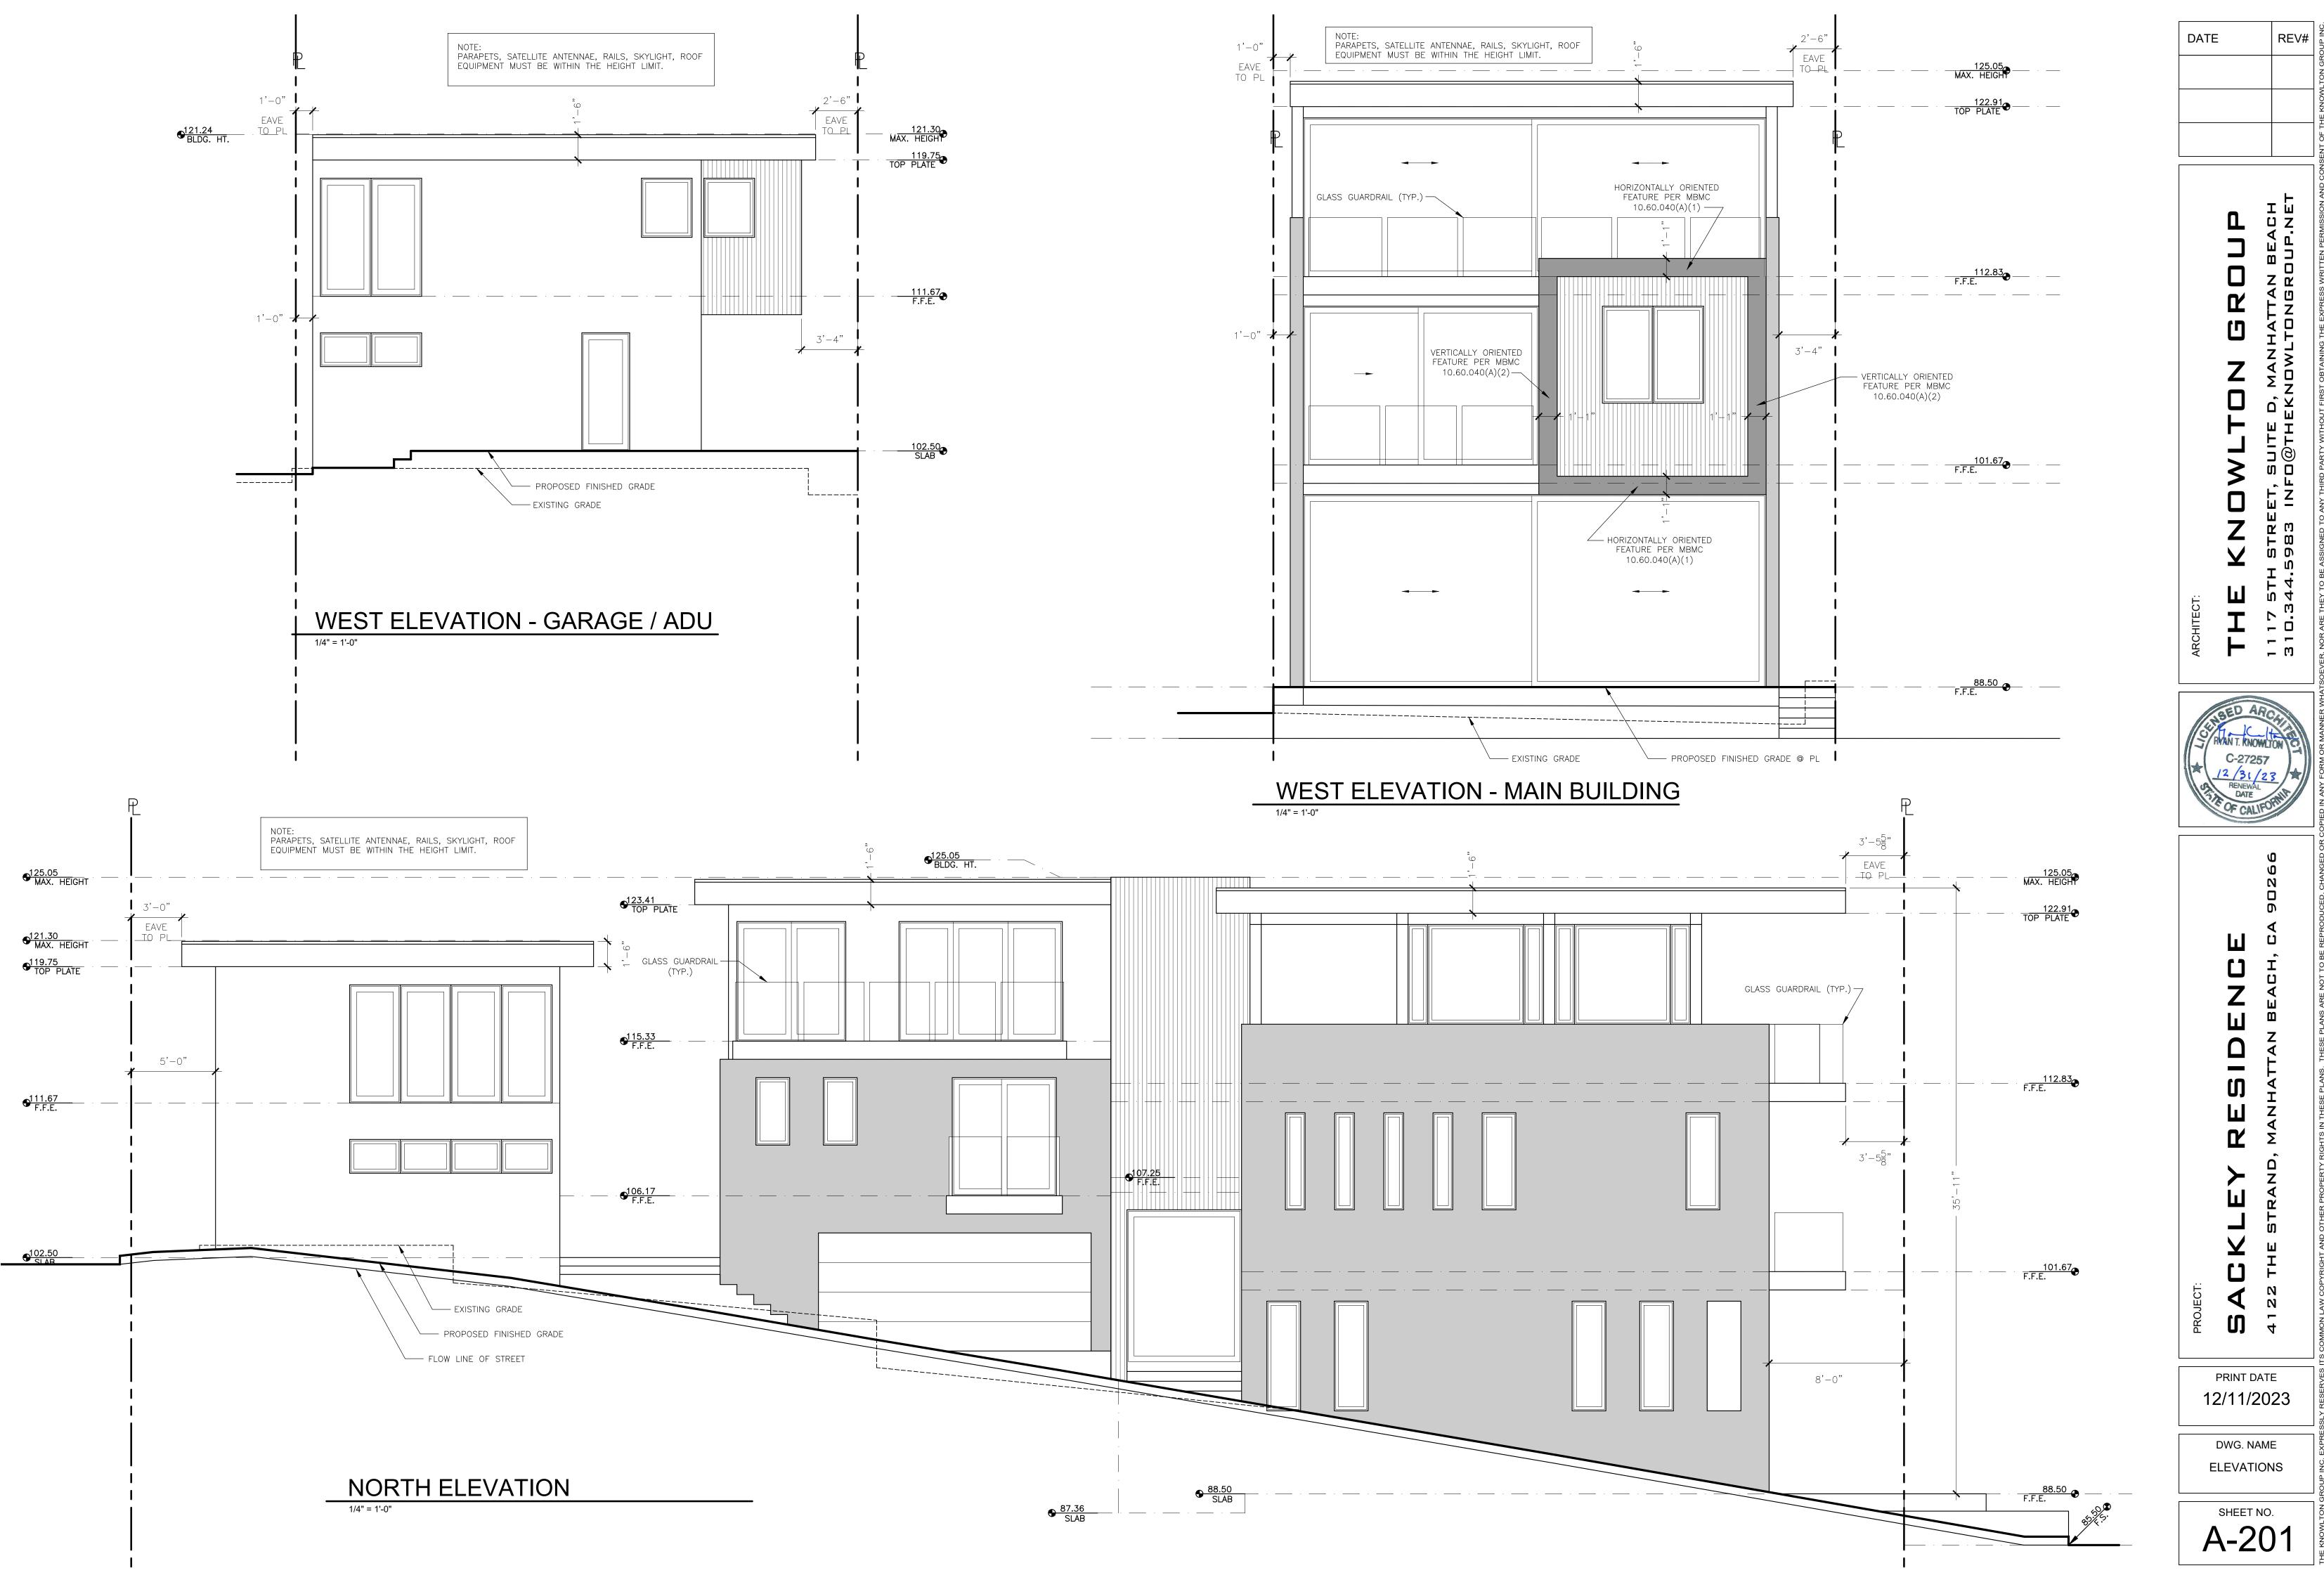

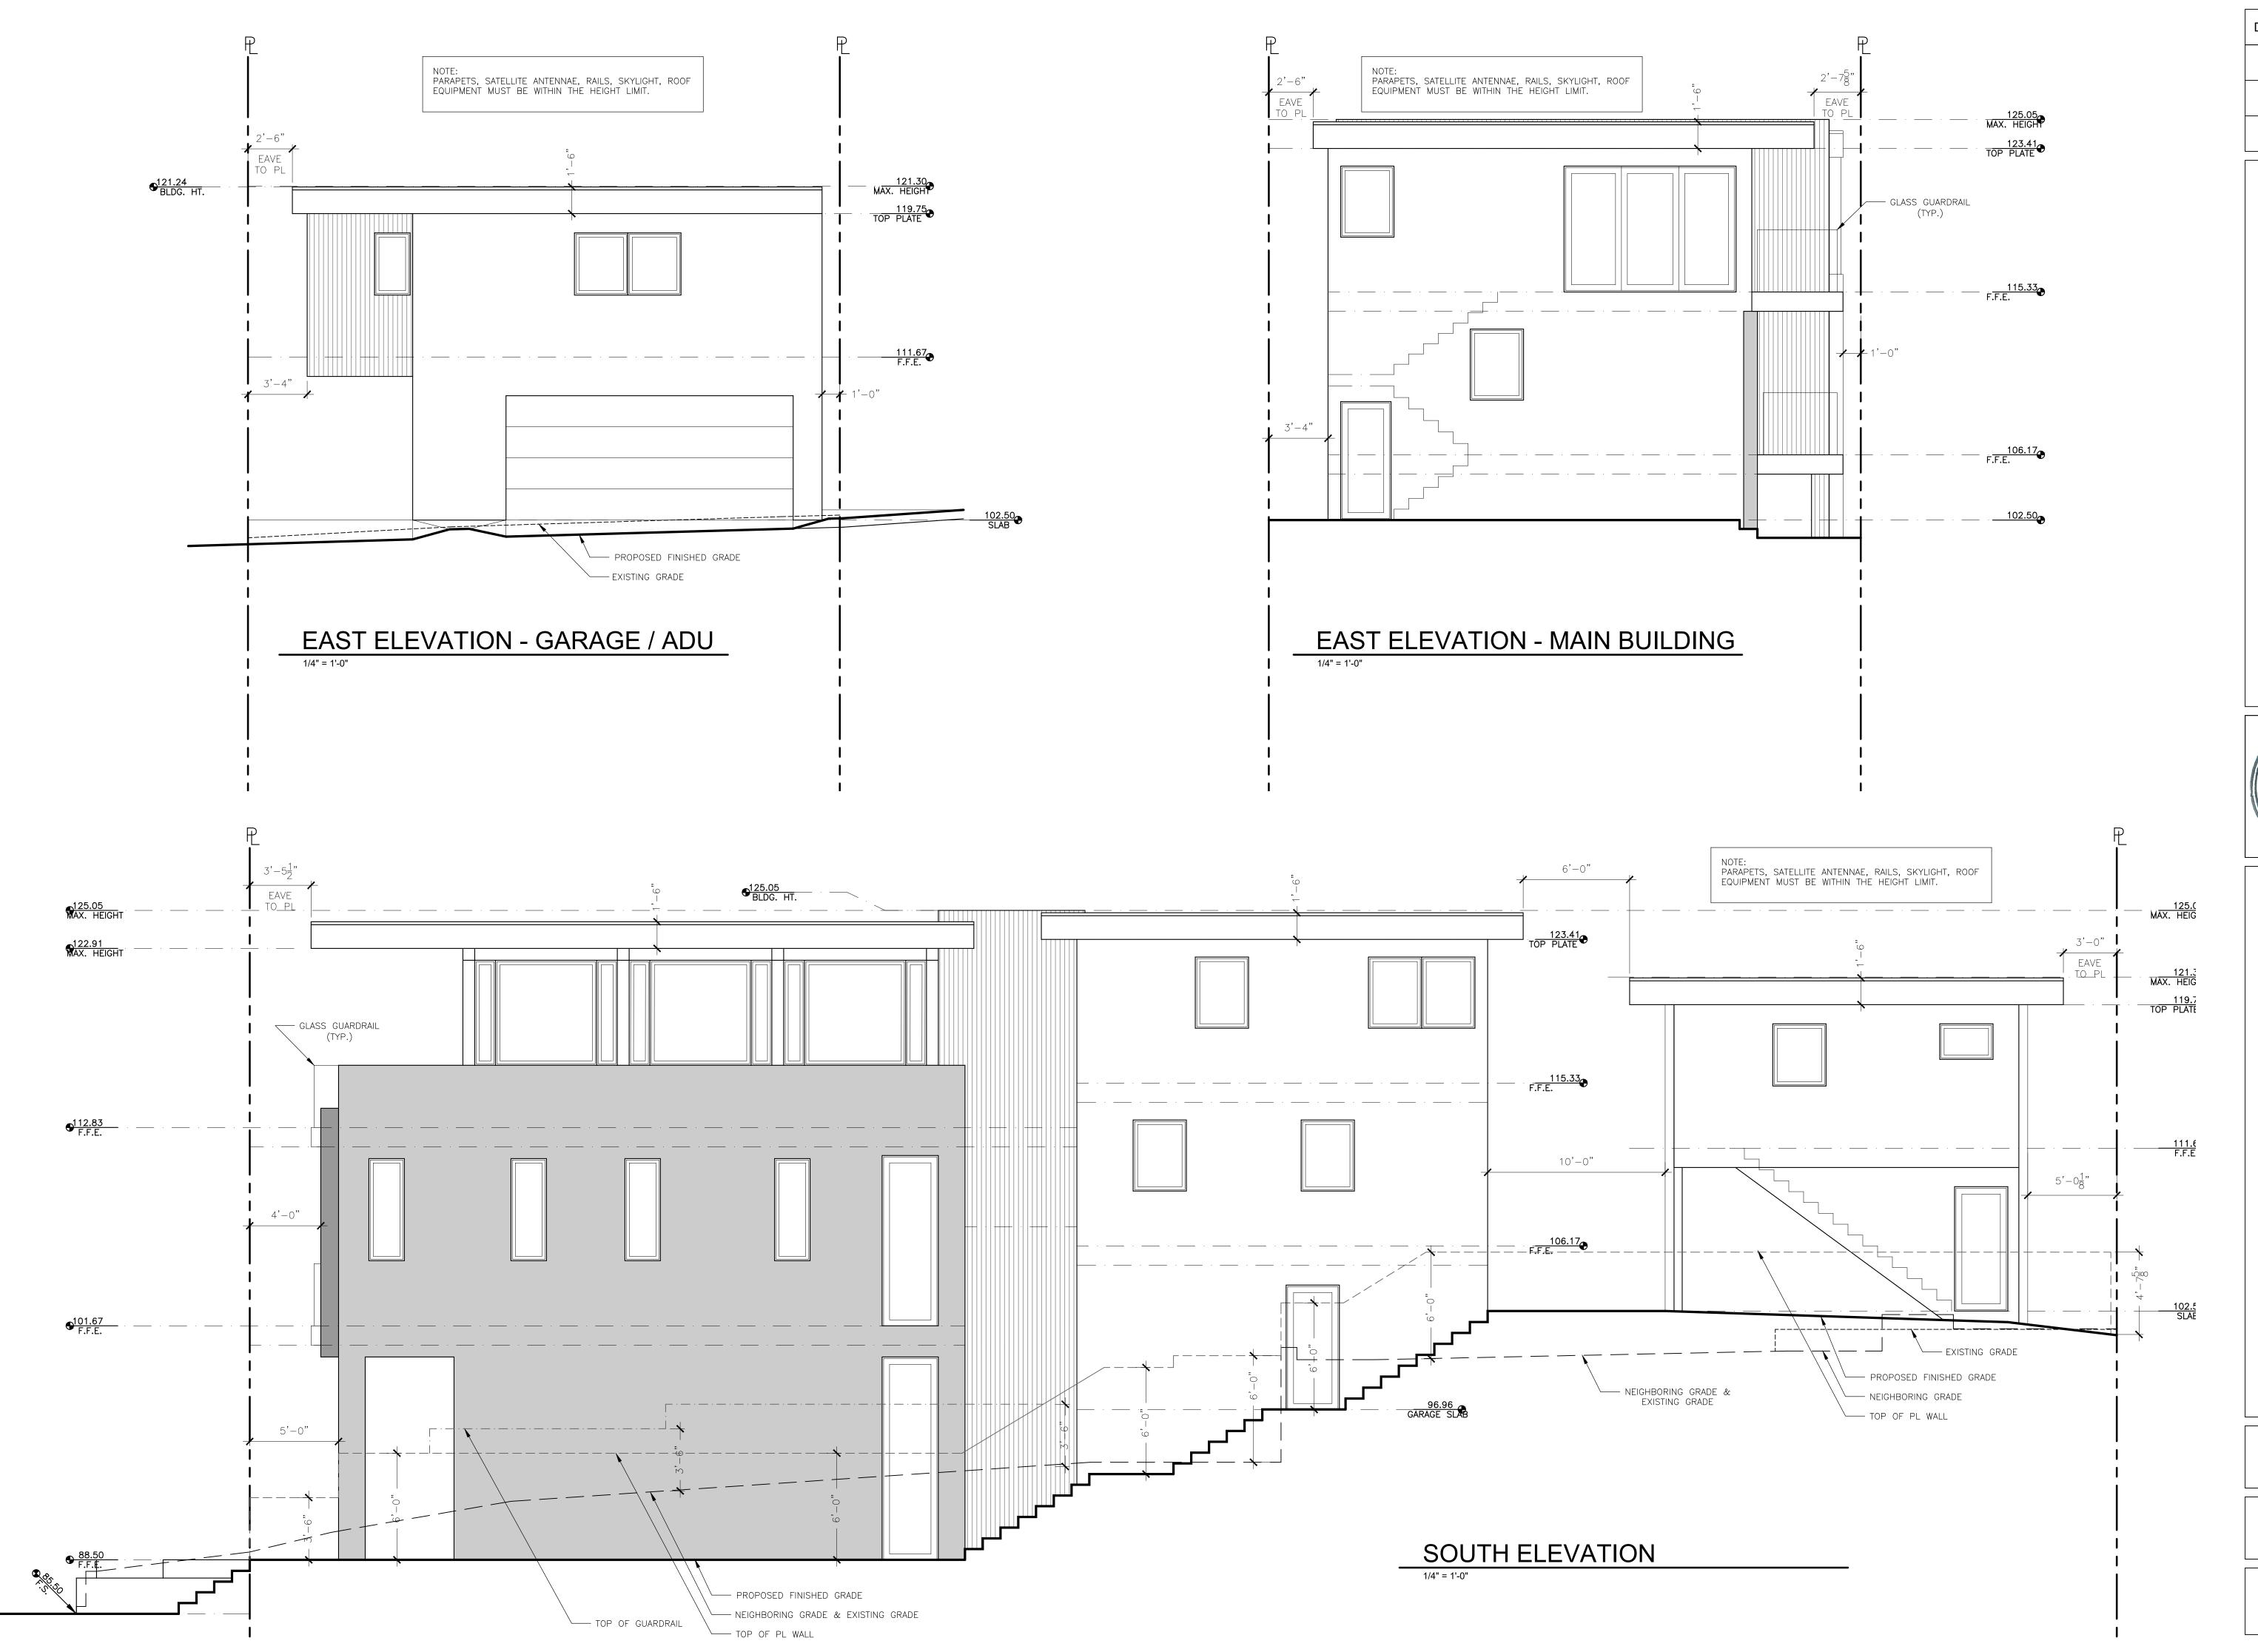

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SAN T. KNOWLTON CO-27257

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ZATENEWAL DATE

CALIFORNIA

RENEWAL DATE

CALIFORNIA


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4122 THE STRAND, MANHATTAN

PRINT DATE 12/11/2023

DWG. NAME
ELEVATIONS



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KLEY RESIDENCE
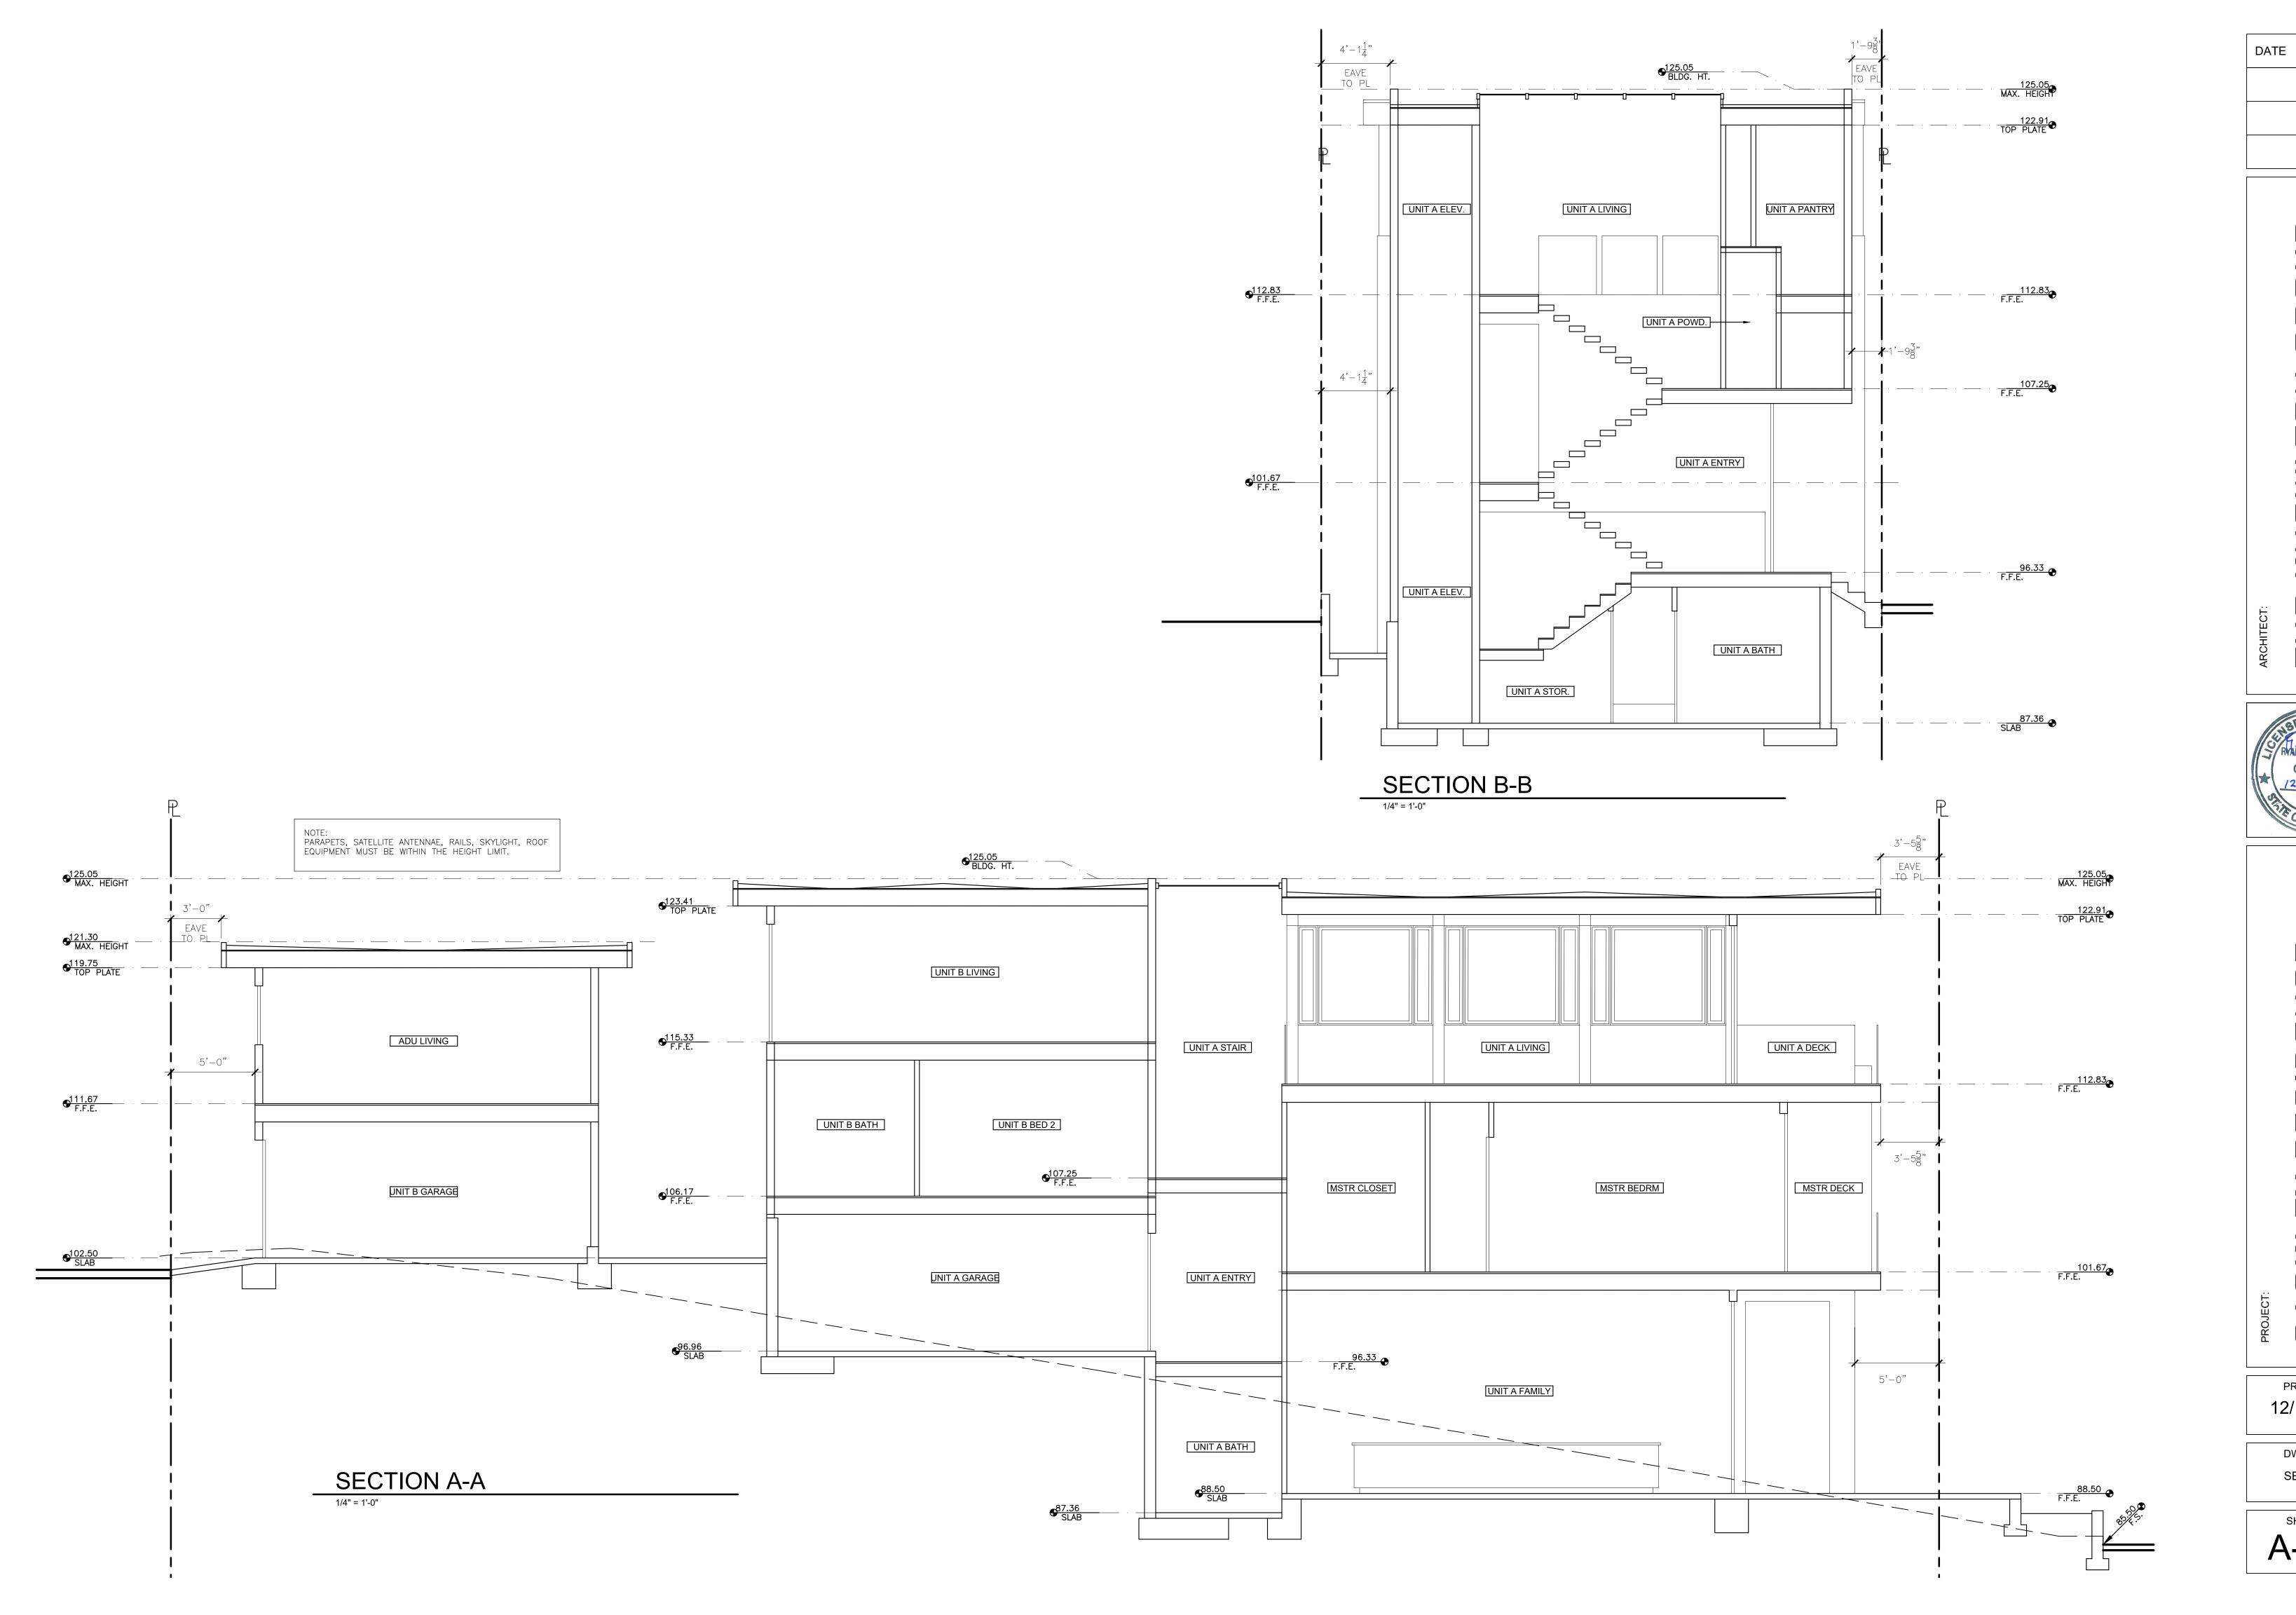
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DWG. NAME SECTIONS