Manhattan Beach, CA 90266-4334

ZONE:

AREA DISTRICT:

BUILDING TYPE: SFR W/ JADU, & ATTACHED ADU

OCCUPANCY GROUP: R3 / U CONSTRUCTION TYPE: TYPE VB

NUMBER OF STORIES:

LOT SIZE: 2,703 SF

LEGAL DESCRIPTION: LOT 5, BLOCK 14 PECK'S MANHATTAN BEACH TRACT

> M.B. 7-34 APN 4177-021-006

PROJECT DATA

SCOPE OF WORK: DEMO OF (E) TRIPLEX;

NEW CONSTRUCTION OF (N) SFR W/ (N) JADU & (N) ATTACHED ADU; (N) EXTERIOR DECKS, (N) LANDSCAPE, (N) HARDSCAPE, (N) SITE FENCES/GATES, (N) RETAINING WALLS

& ASSOCIATED GRADING

WALKING DISTANCE OF PUBLIC TRANSIT.

MAX BUILDING FLOOR AREA: 2,401 SF

MAX BUILDING HEIGHT: 30 FT

REAR YARD SETBACK:

FRONT YARD SETBACK:

3 FT (>8FT ABOVE STREET GRADE)

SIDE YARD SETBACK: 3 FT (SFR) 4 FT (ADU)

1 FT ADJ. TO ALLEY (SFR)

PARKING (SFR + JADU): 2 OFF-STREET SPACES REQUIRED: 2 GARAGE SPACES PROVIDED

5 FT

(SFR < 3,600 SF)

PARKING (ADU): 1 OFF-STREET SPACE REQUIRED (EXEMPT *) * ADU IS LOCATED WITHIN ONE-HALF MILE

2 OFF-STREET PARKING SPACES TOTAL PARKING

HEIGHT CALCULATION

AVERAGE OF CORNER (OR ALTERNATE) GRADE ELEVATIONS (1-4) PLUS HEIGHT LIMIT (7) EQUALS MAXIMUM ALLOWABLE HEIGHT ELEVATION (8).

(1)	(2)	(3)	(4)	(7)	(8)
75.31	80.20	83.03	76.69	30	108.81

MAX. ALLOWABLE HEIGHT ELEVATION = 108.81 FT

BUILDABLE FLOOR AREA

SEE BFA DIAGRAMS ON SHEET A1.1 FOR ADDITIONAL INFO

MAX. ALLOWABLE BUILDING FLOOR AREA: 2,703 SF (LOT SIZE) x 1.7 = 4,595.1 SF 4,595 SF MAX. ALLOWABLE BFA

PROPOSED BUILDABLE FLOOR AREA: 4,104 SF TOTAL (MAIN HOUSE SFR + JADU + ADU)

BUILDABLE FLOOR AREA BREAKDOWN: (EXCLUDING EXEMPT BFA)

LOCATION PROPOSED BFA LEVEL 1 MAIN HOUSE SFR: LEVEL 1 GARAGE: 455 SF 1,178 SF LEVEL 2 MAIN HOUSE SFR: LEVEL 3 MAIN HOUSE SFR: 1,362 SF 3,602 SF SUBTOTAL MAIN HOUSE SFR:

PARKING: **-455** SF

TOTAL MAIN HOUSE SFR: 3,147 SF PROPOSED BFA

374 SF LEVEL 1 JADU: 528 SF LEVEL 2 ADU:

TOTAL PROPOSED SITE BFA: 4,049 PROPOSED SITE BFA (MAIN HOUSE +

JADU + ADU)

GENERAL NOTES 1. GENERAL CONTRACTOR + SUBCONTRACTORS SHALL READ ALL THE NOTES ON THESE PLANS (SET) PRIOR TO SIGNING ANY CONTRACT AND CONSTRUCTION, IF ANY ADDITIONAL INFORMATION ARE REQUIRED TO CLARIFY THE CONTRACTOR SHALL ASK THE ARCHITECT. SEE GENERAL NOTES FOR MORE INFO. 2. AQMD NOTIFICATION IS REQUIRED 10 DAYS BEFORE BEGINNING ANY DEMOLITION WORK. REQUIRED FORM IS AVAILABLE AT THE COMMUNITY DEVELOPMENT DEPARTMENT, PROVIDE PROOF OF NOTIFICATION (MAIL WITH RETURN RECEIPT) 10 DAYS BEFORE BUILDING PERMIT IS ISSUED, OR COMPLETE ASBESTOS NOTIFICATION WAIVER. 3. ALL BUILDING FEATURES PROJECTING INTO REQUIRED SETBACKS SHALL BE INSTALL PER CODE. 4. SEPARATE PERMITS AND PLANS ARE REQUIRED FOR SPAS, POOLS, SOLAR SYSTEMS, DEMOLITION AND SEWER CAP OF EXISTING BUILDINGS. IF SUCH IMPROVEMENTS OR DEMOLITION IS REQUIRED AS A CONDITION OF APPROVAL FOR DISCRETIONARY ACTIONS OR TO COMMENCE BUILDING, THEN SUCH PERMITS MUST BE OBTAINED BEFORE OR AT THE TIME THE PROPOSED BUILDING PERMIT IS ISSUED 5. SOILS REPORT SHALL BE PROVIDED TO THE BUILDING DEPARTMENT FOR ALL CUTS, FILLS, AND EARTHWORK AS REQ'D PER CODE. 6. STUMPS AND ROOTS SHALL BE REMOVED TO A DEPTH OF 12" IN THE AREA OCCUPIED BY THE BUILDING.

7. ALL HOSE BIBS MUST BE PROTECTED BY BACK FLOW PREVENTION AND HAVE AN ANTI-SIPHON DEVICE. 8. ALL WINDOW COVERINGS REQUIRED BY CFIR. FORM SHALL BE POSTED PRIOR TO FINAL INSPECTION. 9. WRITTEN APPROVAL FROM THE SOUTH COAST AIR QUALITY MANAGEMENT DISTRICT (SCAQMD), (714)396:2000 PER RULE 1403 FOR THE PROPER DISPOSAL OF ASBESTOS

10. ONLY LOS ANGELES COUNTY HEALTH DEPARTMENT APPROVED DEVICES MAY BE UTILIZED FOR LANDSCAPE IRRIGATION BACK FLOW PREVENTION DEVICES.

11. VERIFY CLEARANCES WITH OVERHEAD UTILITY LINES FROM ALL PERMANENT AND TEMPORARY STRUCTURE INCLUDING SCAFFOLDING AND OTHER WORKING AREAS DURING CONSTRUCTION. CLEARANCE TO BE 8 FT. HORIZONTAL AND 12

FT. VERTICAL. VERIFY WITH SOUTHERN CALIFORNIA EDISON CO. BEFORE COMMENCING CONSTRUCTION. 12. PROVIDE SURVEY STAKES PRIOR TO FOUNDATION INSPECTION TO VERIFY LOT LINES.

13. THE ARCHITECT IS NOT RESPONSIBLE FOR SITE GRADING OR DRAINAGE. CONTRACTOR SHALL CONSULT A LICENSED CIVIL ENGINEER. 14. IT IS THE GENERAL CONTRACTORS/BUILD. CONTRACTOR

RESPONSIBILITY TO VERIFY THAT THE BUILDING IS WITHIN THE HEIGHT LIMIT PRIOR TO FRAMING THE ROOF RAFTERS. CONTACT THE CIVIL SURVEY CONSULTANTS.

15. ALL EXISTING SURFACE DRAINAGE WHICH IS ALTERED DUE TO NEW BUILDING ADDITION SHALL BE MODIFIED TO PROVIDE AND TERMINATE AT PUBLIC RIGHT OF WAY VIA -NON EROSIVE DEVISE PER CITY HAVING JURISDICTION. NO SURFACE WATER

SHALL CROSS OVER NEIGHBORING PROPERTY LINE. 16. CONTRACTOR TO SCHEDULE APPOINTMENT WITH SOUTHERN CALIFORNIA EDISON FOR TEMPORARY POWER AND LOCATION OF SERVICE. 17. CONTRACTOR SHALL POST THE INSTALLATION CERTIFICATE (CF-6R) FORM AND INSULATION CERTIFICATE (IC-1) FORM IN A

AVAILABLE TO THE INSPECTOR. 18. CONTRACTOR SHALL PROVIDE COPIES OF THE CALIFORNIA GUIDE TO HOME COMFORT AND ENERGY SAVINGS, CF-1R, MF-1R, CF-6R AND IC-1 FORM TO THE BUILDING OWNER. 19. PROVIDE UNDERGROUND DRAINAGE SYSTEM FOR DOWN SPOUTS, PLANTER AREAS, AND ALL AREAS REQUIRING

CONSPICUOUS LOCATION OR KEPT WITH PLANS AND MADE

POSITIVE DRAINAGE. 20. SLOPE ALL PROPOSED SURFACE WATER RUNOFF TOWARDS STREET. CONTRACTOR TO CONFIRM AND VERIFY 1% MIN. SLOPE REQUIRED. NO SURFACE RAIN WATER RUNOFF AND OR IRRIGATION RUNOFF SHALL CROSS OVER NEIGHBORING PROPERTIES. 21. BUILDING ADDRESS SHALL BE PROVIDED ON THE BUILDING IS SUCH A POSITION AS TO BE PLAINLY VISIBLE & LEGIBLE FROM

22. THIS BUILDING SITE SHALL COMPLY WITH PROTECTION OF PEDESTRIANS DURING CONSTRUCTION. PER CRC SECTION 318.3 23. THE BLDG. SHALL COMPLY WITH SECURITY REQMTS. 24. COOKING EQUIPMENT MUST BE LISTED FOR RESIDENTIAL USE. 25. LOCATION OF SERVICES SHALL BE APPROVED BY SOUTHERN

UTILITY COMPANIES. 26. CONTRACTOR SHALL SUBMIT TEMPORARY SHORING PLAN (UNDER SEPARATE PERMIT) WHERE OCCURS 27. ALL WORK IN THE PUBLIC RIGHT OF WAY MUST BE ACCOMPANIED BY AN ENCROACHMENT PERMIT ISSUED BY THE PUBLIC WORKS DEPARTMENT

CALIFORNIA EDISON COMPANY, GAS COMPANY AND ALL OTHER

28. ALL ABOVE-GROUND EXTERIOR CONDUIT MUST BE RIGID GALV. STEEL OR SCHED. 80 SUNLIGHT-RESISTANT NON-METALLIC CONDUIT (MBMC 9.12.050) 29. ALL CONDUCTORS SHALL BE MADE OF COPPER (MBMC 9.12.060)

OPEN SPACE AREA

STREET, PER CRC SECTION 319.1

SEE OPEN SPACE DIAGRAMS ON SHEET A1.1 FOR ADDITIONAL INFO **OPEN SPACE BREAKDOWN:**

TOTAL PROPOSED MAIN HOUSE SFR BFA x 15% (EXCLUDES JADU & ADU BFA)

OPEN SPACE AREA: 3,147 SF x 15% = 472 SF 472 SF MIN. REQUIRED

501 SF OPEN SPACE PROVIDED

472 SF / 2 = **236** SF 236 SF MAX. LEVEL 3 OPEN SPACE *


LOCATION PROPOSED OPEN SPACE LEVEL 1 OPEN SPACE: 160 SF LEVEL 2 OPEN SPACE: 105 SF **LEVEL 3 OPEN SPACE:** 475 SF (240 SF MAX. *)

TOTAL OPEN SPACE: **501 SF OPEN SPACE** PROVIDED



216 25TH ST. 216A 25TH ST 216B 25TH ST.

SHEET INDEX SHEET NAME SHEET# TITLE SHEET SITE PLAN, DEMO PLAN, & AREA DIAGRAMS LEVEL 1 & LEVEL 2 FLOOR PLANS LEVEL 3 FLOOR PLAN & ROOF PLAN **EXTERIOR ELEVATIONS** EXTERIOR ELEVATIONS BUILDING SECTIONS BUILDING SECTIONS

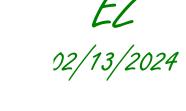



COMPLY WITH 2022 CALIFORNIA BUILDING STANDARDS CODE

BEST MANAGEMENT PRACTICE (BMP)

1. ALL PERSONS WORKING AT THE SITE SHOULD OBTAIN, READ AND **UNDERSTAND THE BEST MANAGEMENT PRACTICES**

PAMPHLET FOR THE TYPE OF CONSTRUCTION BEING DONE. 2. STOCKPILES OF SOIL DEBRIS CEMENT SAND TOP-SOIL ETC MUST BE COVERED WITH WATERPROOF MATERIAL OR

BERMED TO PREVENT BEING WASHED AWAY. 3. FUELS OILS PAINTS SOLVENTS AND OTHER LIQUID MATERIALS MUST BE KEPT INSIDE BERMED AREAS. SPILLS MUST NOT BE

WASHED INTO THE STREET. 4. WASTE CONCRETE MUST NOT BE WASHED INTO THE STREET, STORM DRAINS OR PUBLIC RIGHT OF WAY. ALL DUST AND

SLURRY FROM CONCRETE CUTTING MUST ME REMOVED USING WET/DRY VAC OR EQUIVALENT. 5. TRASH AND OTHER CONSTRUCTION SOLID WASTE MUST BE PLACED IN A

COVERED TRASH RECEPTACLE. ERODED SOIL FROM DISTURBED SLOPES MUST BE CONTAINED USING BERM SILT FENCES SETTING BASINS OR GOOD EROSION

MANAGEMENT PRACTICES. 6. WASH WATER FOR CLEANING CONSTRUCTION EQUIPMENT MUST BE KEPT ON-SITE WITHIN A CONTAINMENT AREA BEST

CITY, STATE, NATIONALLY

2022 CALIFORNIA BUILDING CODE, 2022 CALIF. GREEN BUILDING CODE,

2022 CALIF. RESIDENTIAL CODE. 2022 CALIFORNIA PLUMBING CODE,

2022 CALIFORNIA ELECTRICAL CODE. T-24 ENERGY CONSERVATION

REGULATIONS. STATE OF CALIFORNIA AND CITY OF HAWTHORNE

APPLICABLE CODES

2022 CALIFORNIA MECHANICAL CODE.

AND 2022 CALIFORNIA RESIDENTIAL CODE

Manhattan Beach, California 90266

BUILDING SHALL COMPLY WITH

BUILDING ADDRESS SHALL BE PROVIDED ON BUILDING IN SUCH POSITION TO BE PLAINILY VISIBLE FROM THE STREET

PROVIDE WATER CONSERVATIONS FIXTURES PER CGBC 4.303. THESE INCLUDE 1.28 GPF WC, MAXIMUM 2.0 GPM @80 PSI FOR SINGLE SHOWER HEADS.

PROVIDE COPY OF OPERATION AND MAINTENANCE MANUAL AT TIME OF FINAL **INSPECTION PER CGBC 4.410.1.**


EACH BATHROOM SHALL BE MECHANICALLY VENTILATED AND EITHER BE ENERGY STAR COMPLIANT AND BE DUCTED TO TERMINATE OUTSIDE THE BUIILDING OR MUST BE CONTROLLED BY HUMIDITY CONTROL PER CGBC 4.506.1

GAS FIREPLACES SHALL BE DIRECT-VENT SEALED-COMBUSTION TYPE. ANY INSTALLED WOODSTOVE OR PELLET STOVE SHALL COMPLY WITH US EPA PHASE **II EMISSION LIMITS PER CGBC 4.503.**

PROJECT DIRECTORY

PROJECT ARCHITECT / DESIGNER

Pablo Escutia e² Design Studio 3216 Manhattan Ave Suite E Hermosa Beach, CA 90254 (310) 372-6027 pablo@e2designstudio.com

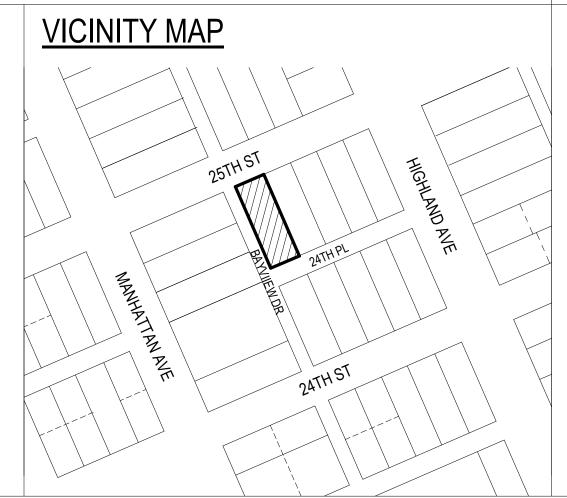





03/04/2024

<u>lesian studio</u>

436 29TH STREET HERMOSA BEACH, CA E2DESIGNSTUDIO.COM 310.658.0993 PROJECT

MAIMONE RESIDENCE 216 25TH ST 216A 25TH ST. 216B 25TH ST. **MANHATTAN BEACH, CA 90266** PROJECT NO. 000

PLANNING SUBMITTAL 04/21/2023 2 PLANNING SUBMITTAL 09/15/2023


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TITLE SHEET

3" = 1'-0" SCALE:

DRAWN BY:



NOTE:
A TITLE POLICY HAS BEEN PROVIDED AND REVIEWED BY DENN ENGINEERS AT THE TIME OF THIS SURVEY.

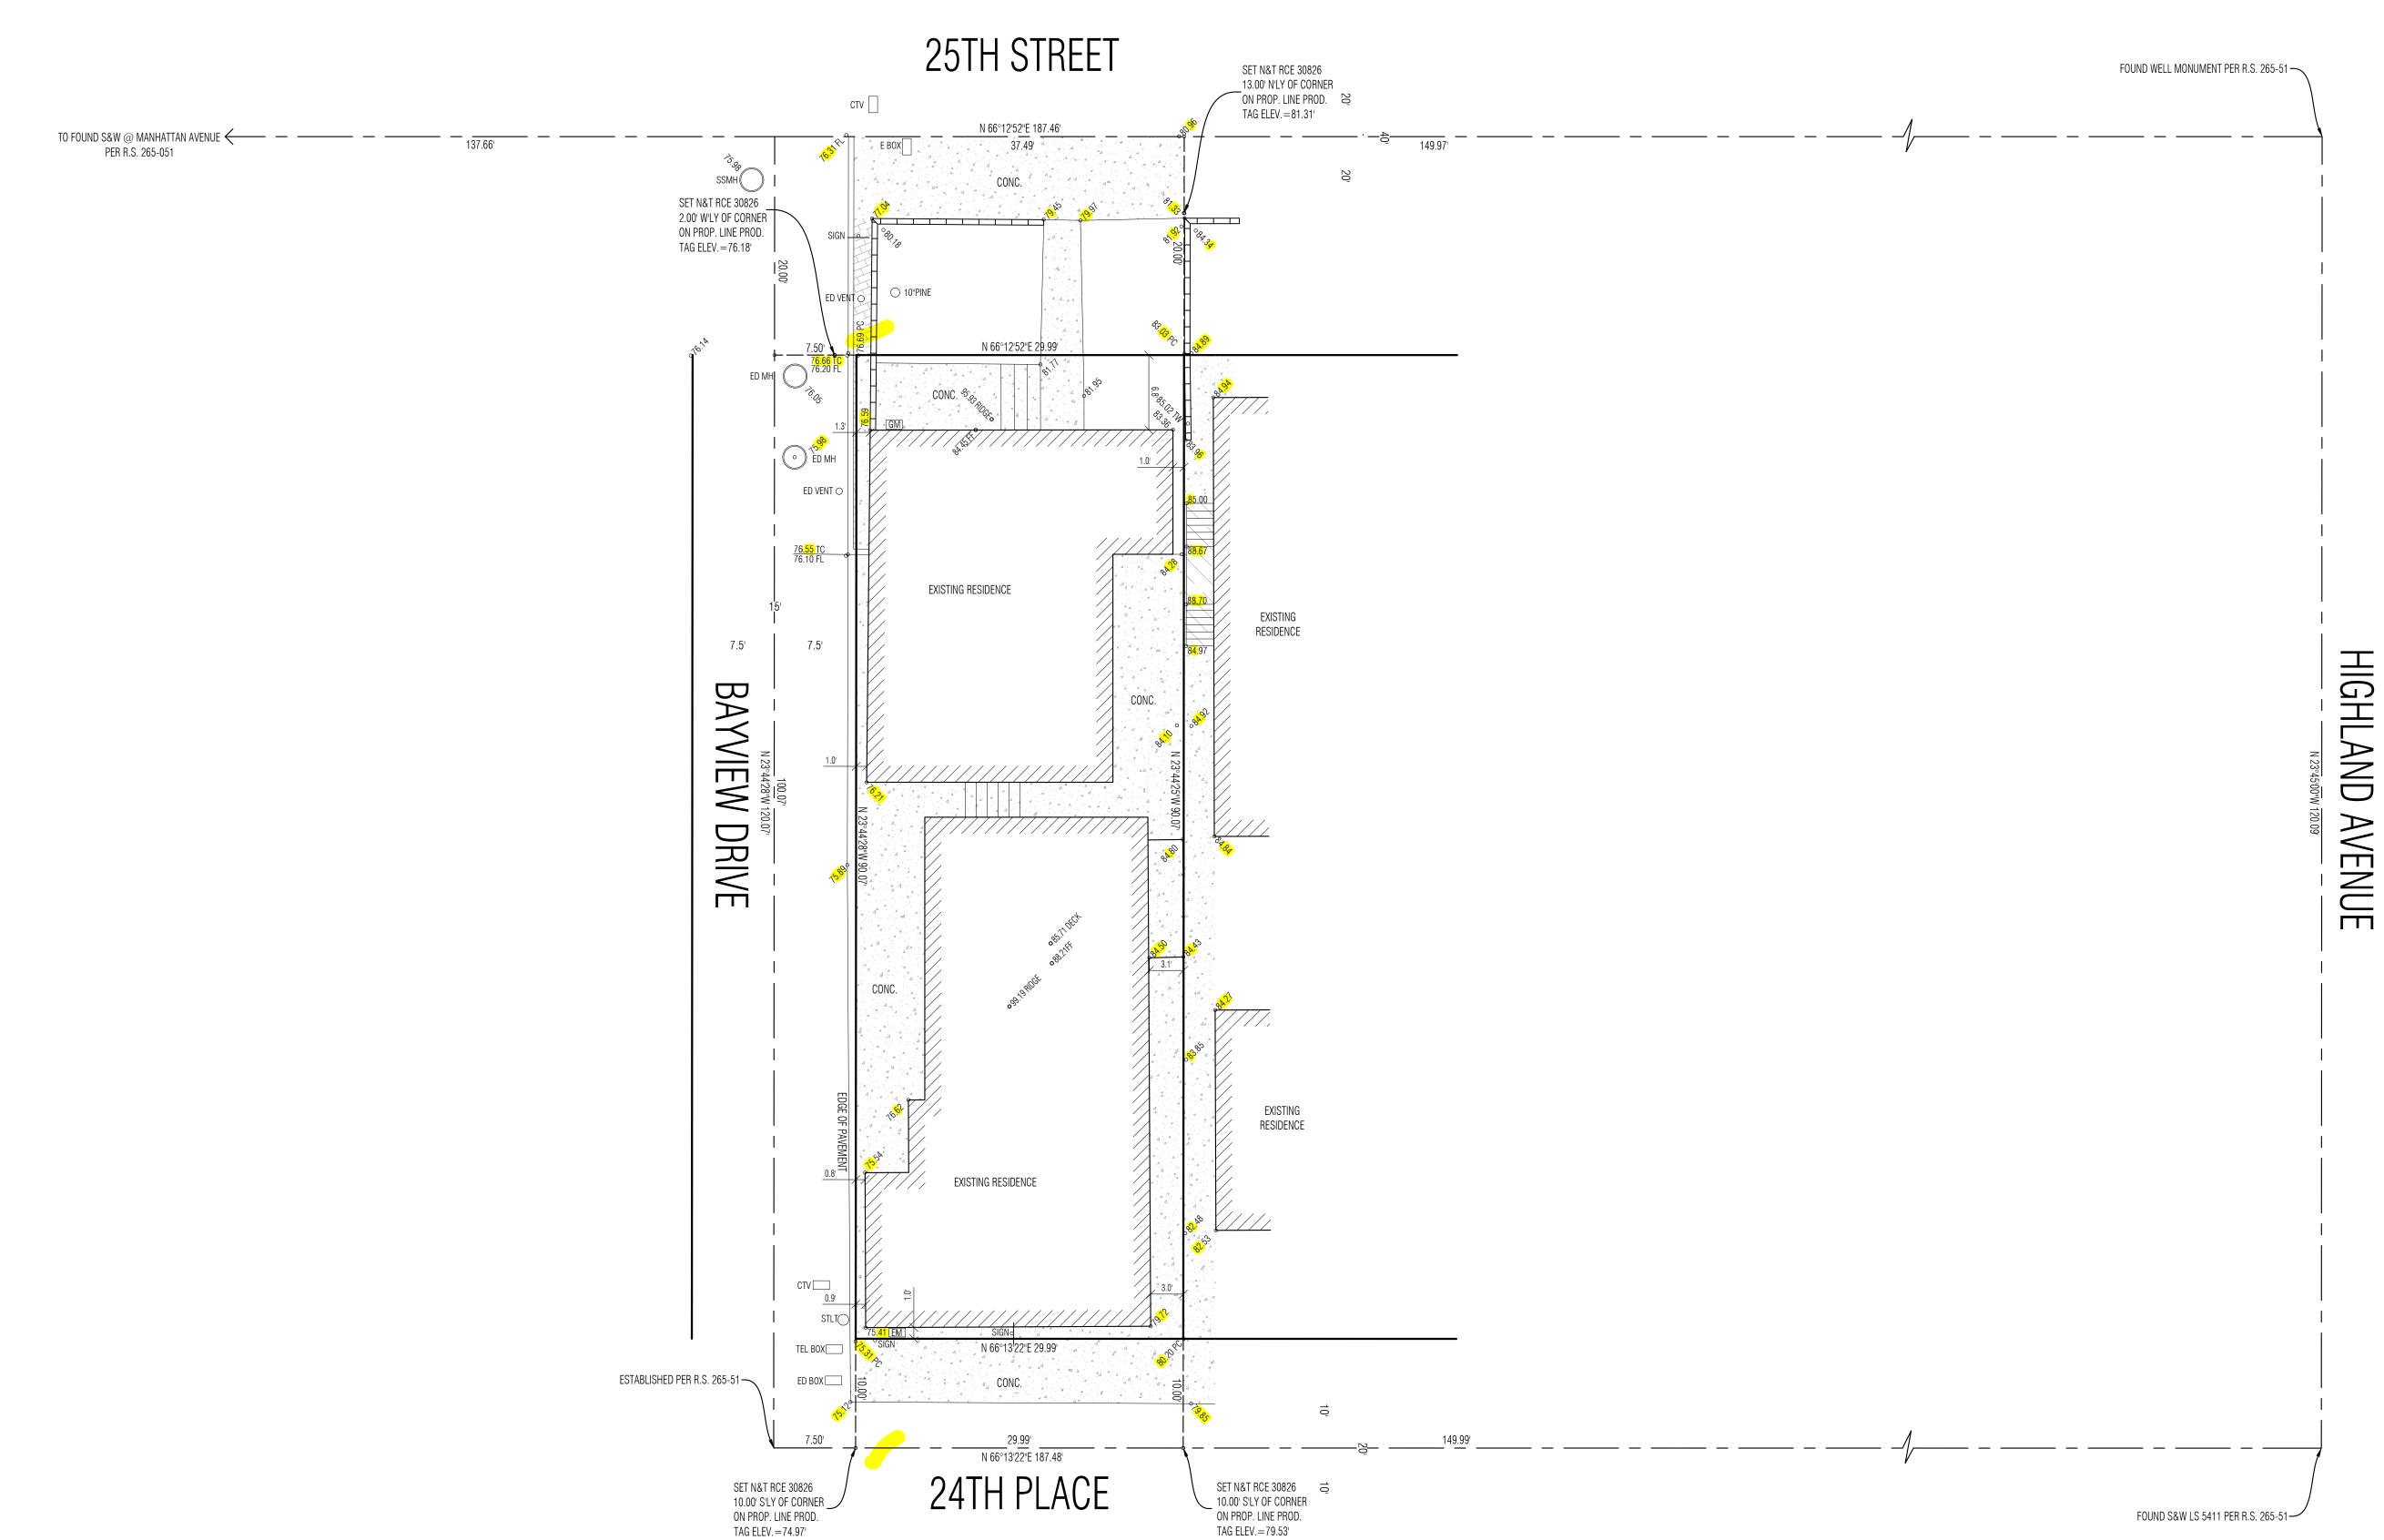NO EASEMENTS WERE IDENTIFIED ON THE PROVIDED TITLE REPORT PER THE FOLLOWING:

USA NATIONAL TITLE COMPANY ORDER NO. 072333663-30

DATED JANUARY 26, 2023



SCALE 1" = 8'

TORRANCE, CA 90503 (310) 542-9433

SURVEY AND TOPOGRAPHY

JESSICA & TIM MAIMONE 5135 ISLAND FOREST PLACE WESTLAKE VILLAGE, CA 91362 PHONE 425-221-0100

JOB ADDRESS 216 25TH STREET

MANHATTAN BEACH, CA 90266

LEGAL DESCRIPTION

LOT 5, BLOCK 14 PECK'S MANHATTAN BEACH TRACT M.B. 7-34 APN 4177-021-006

THIS MAP CORRECTLY REPRESENTS A SURVEY MADE BY ME OR UNDER MY DIRECTION IN CONFORMANCE WITH THE REQUIREMENTS OF PROFESSIONAL LAND SURVEYORS' ACT



GARY J. ROEHL

R.C.E. 30826

DRAWN ON

LEGEND

EXISTING BUILDING CONCRETE • 106.76 EXISTING ELEVATION 100 _ EXISTING CONTOUR BLOCK WALL — X — EXISTING FENCE BEGINNING OF CURB RETURN CABLE TV PULL BOX CONCRETE

CITY ENGINEERS FIELD BOOK C.L.F. / W.I.F. CHAIN LINK FENCE / WROUGHT IRON FENCE EASTERLY EDGE OF GUTTER ELECTRIC METER FINISH FLOOR FIRE HYDRANT FLOW LINE

GARAGE FINISH FLOOR GAS METER GUY / GW GUY WIRE IRON PIPE MONUMENT LEAD AND TACK / TAG MONUMENT MANHOLE (SANITARY SEWER / STORM DRAIN) NORTHERLY NAIL AND TAG MONUMENT PULL BOX (EDISON / TRAFFIC / STREET LIGHT

TELEPHONE / CABLE TV)

PROPERTY CORNER / PROP. CORNER PROPERTY LINE / PROP. LINE POWER POLE / UTILITY POLE PUBLIC WORKS FIELD BOOK RAIL ROAD ROAD DEPARTMENT FIELD BOOK

RECORD OF SURVEY SPK / S&W SPIKE / SPIKE AND WASHER MONUMENT SANITARY SEWER CLEANOUT STK / STK&T STAKE / STAKE AND TAG MONUMENT STLT / LT STREET LIGHT POLE / LIGHT POLE TOP OF CURB

TX / BX TOP OF APRON / BOTTOM OF APRON
WLY WESTERLY
WM WATER METER NOTE: ALL SETBACK DIMENSIONS SHOWN ARE MEASURED TO EXTERIOR SURFACE OF


BUILDINGS UNLESS OTHERWISE NOTED. BOUNDARY MONUMENTS ARE NOT NECESSARILY SET ON PROPERTY CORNERS. PLEASE REFER TO THE NOTATION ON THIS SURVEY PLAT FOR OFFSET DIMENSIONS. IF THERE ARE ANY QUESTIONS, PLEASE DO NOT HESITATE TO CONTACT DENN ENGINEERS FOR CLARIFICATION BY PHONE AT:

(310) 542-9433, M-F 8:00 AM TO 5:00 PM.

ANY CHANGES OR MODIFICATIONS MADE TO THIS PLAN WITHOUT WRITTEN CONSENT OF DENN ENGINEERS SHALL RELIEVE DENN ENGINEERS FROM ANY LIABILITY OR DAMAGE RESULTING FROM SUCH CHANGES OR MODIFICATIONS, INCLUDING ANY ATTORNEYS FEES OR COSTS INCURRED IN ANY PROCEEDING THAT DENN ENGINEERS MAY BE JOINED.

SHEET 1 OF 1

JOB NO. 15-357B

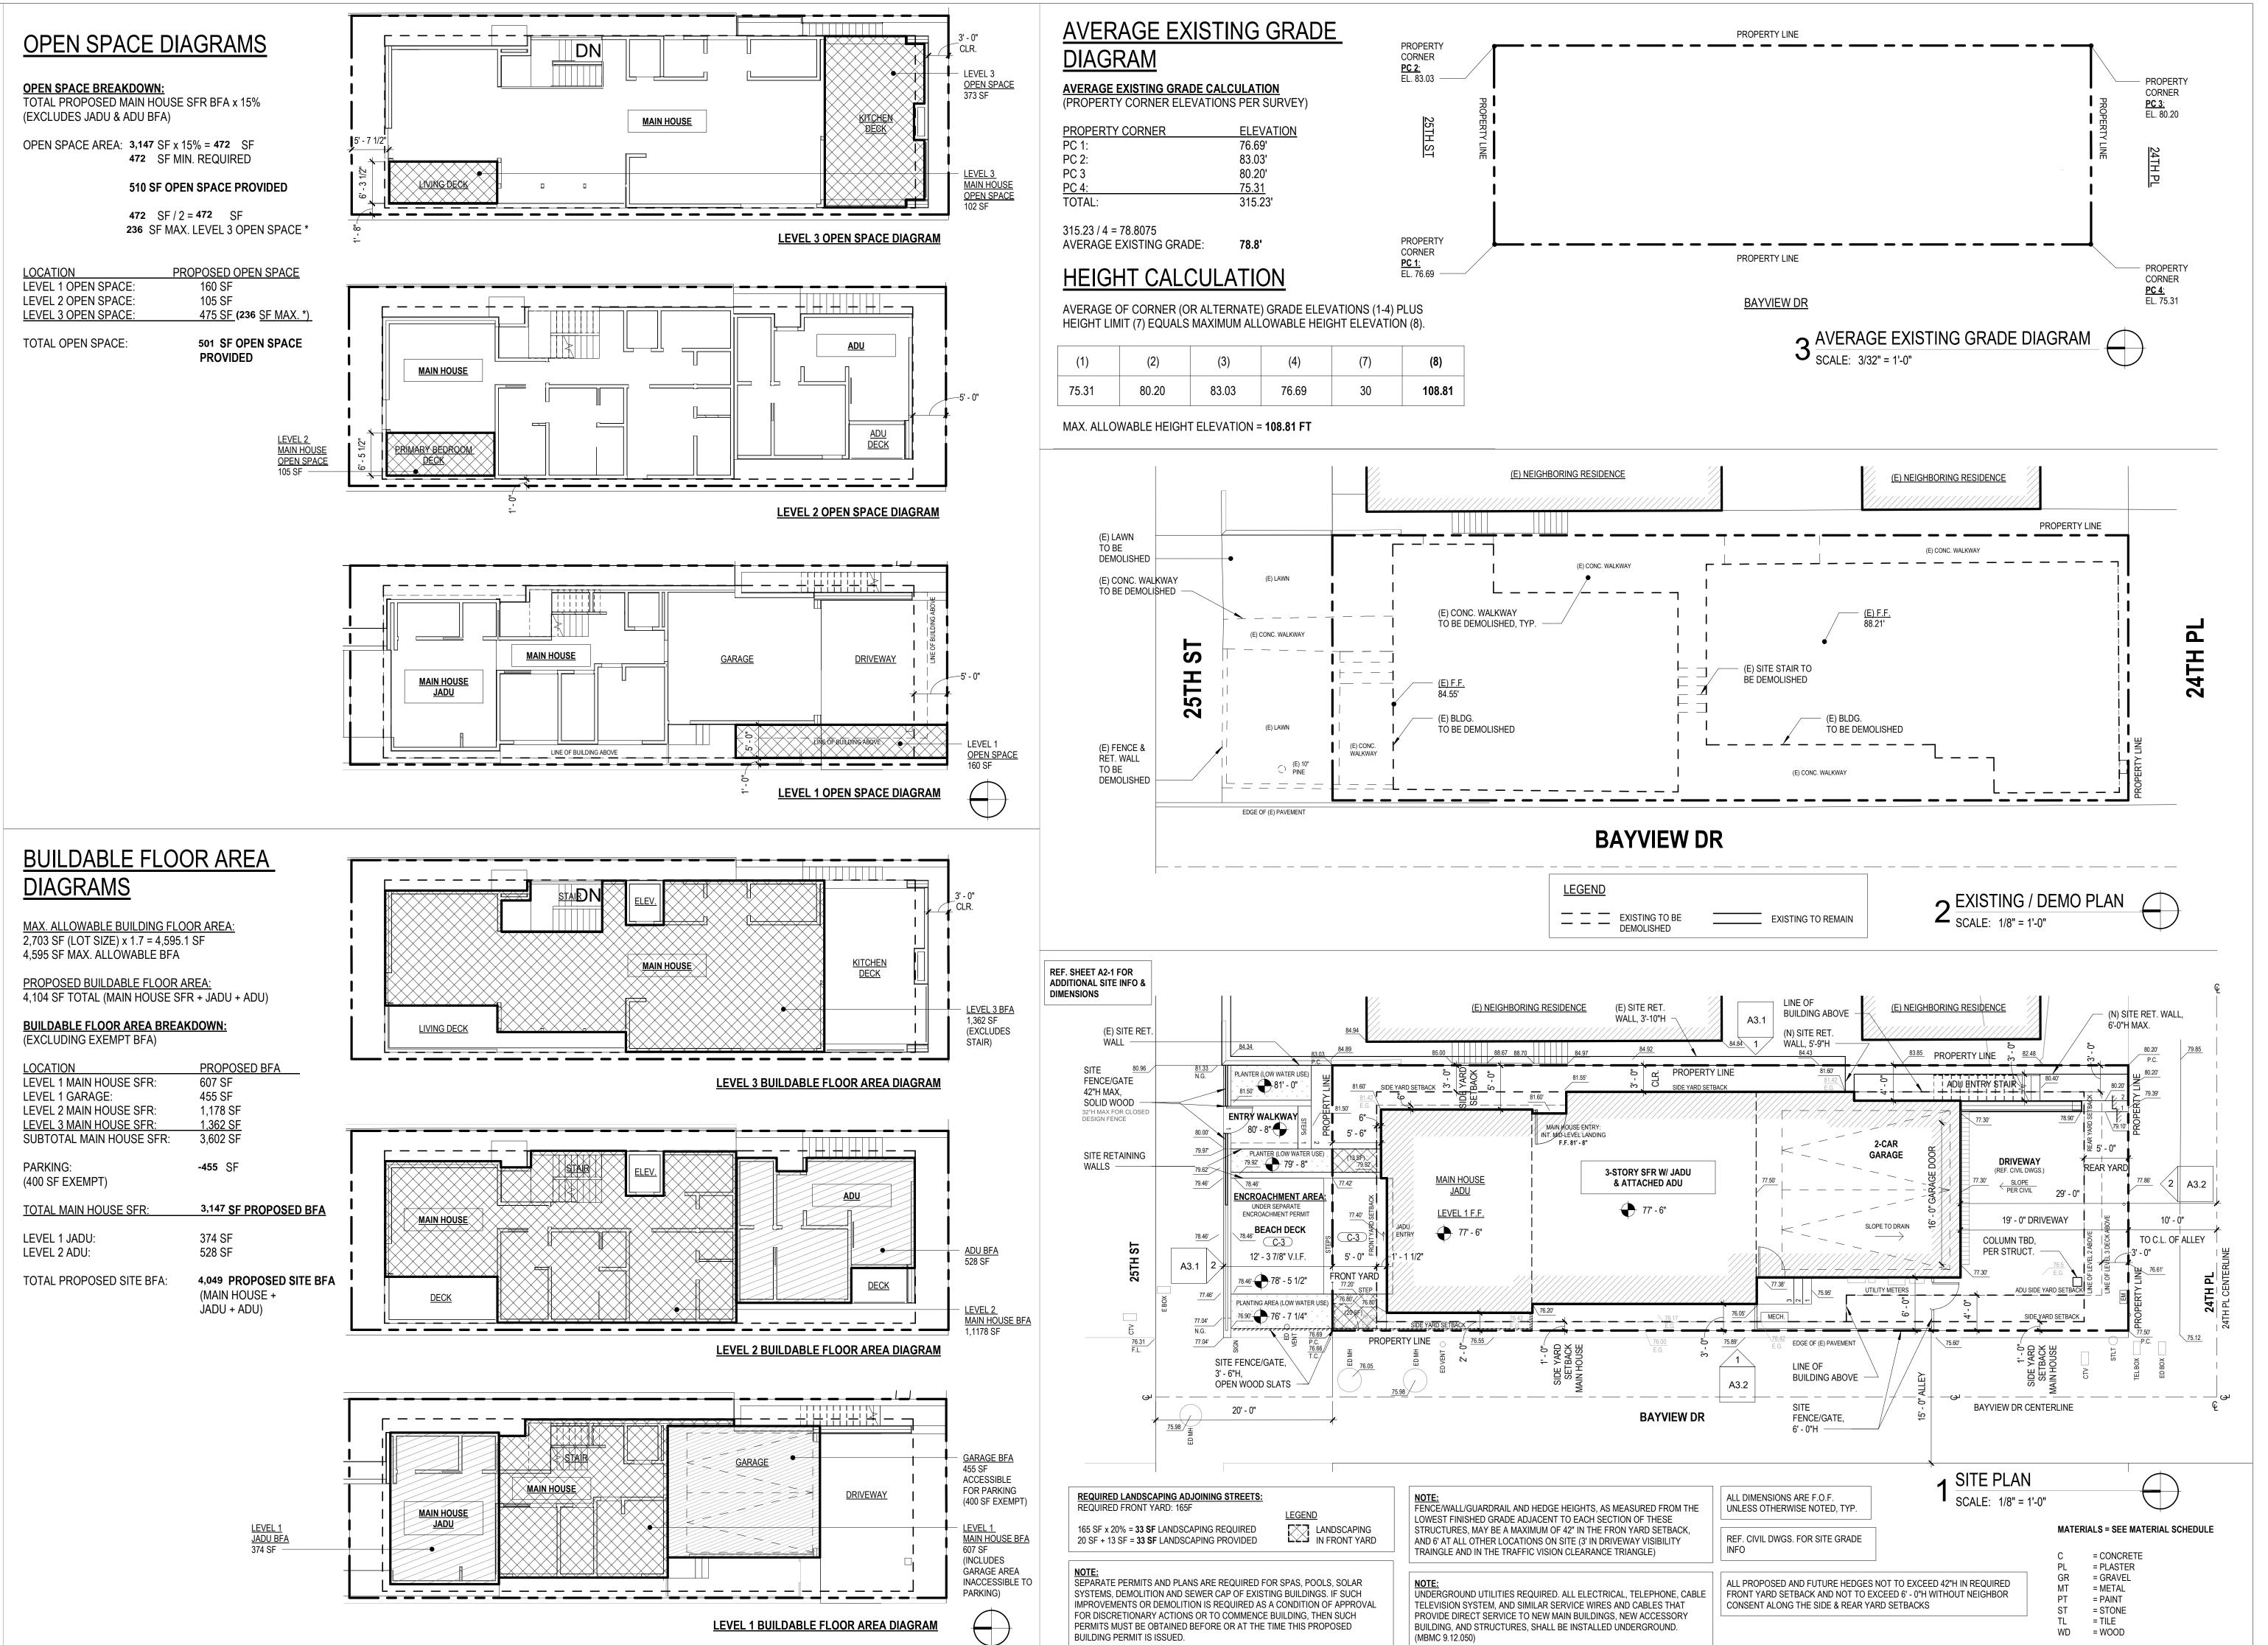



436 29TH STREET
HERMOSA BEACH, CA

PABLO@E2DESIGNSTUDIO.COM

E2DESIGNSTUDIO.COM

310.658.0993

MAIMONE
RESIDENCE
216 25TH ST.
216A 25TH ST.
216B 25TH ST.
MANHATTAN BEACH, CA 90266
DATE: 01/15/24

 REVISION:
 DATE

 1 PLANNING SUBMITTAL
 04/21/2023

 2 PLANNING SUBMITTAL
 09/15/2023

 3 PLANNING/CACC SUBMITTAL
 01/15/2024

 4
 5

PROJECT NO. 000

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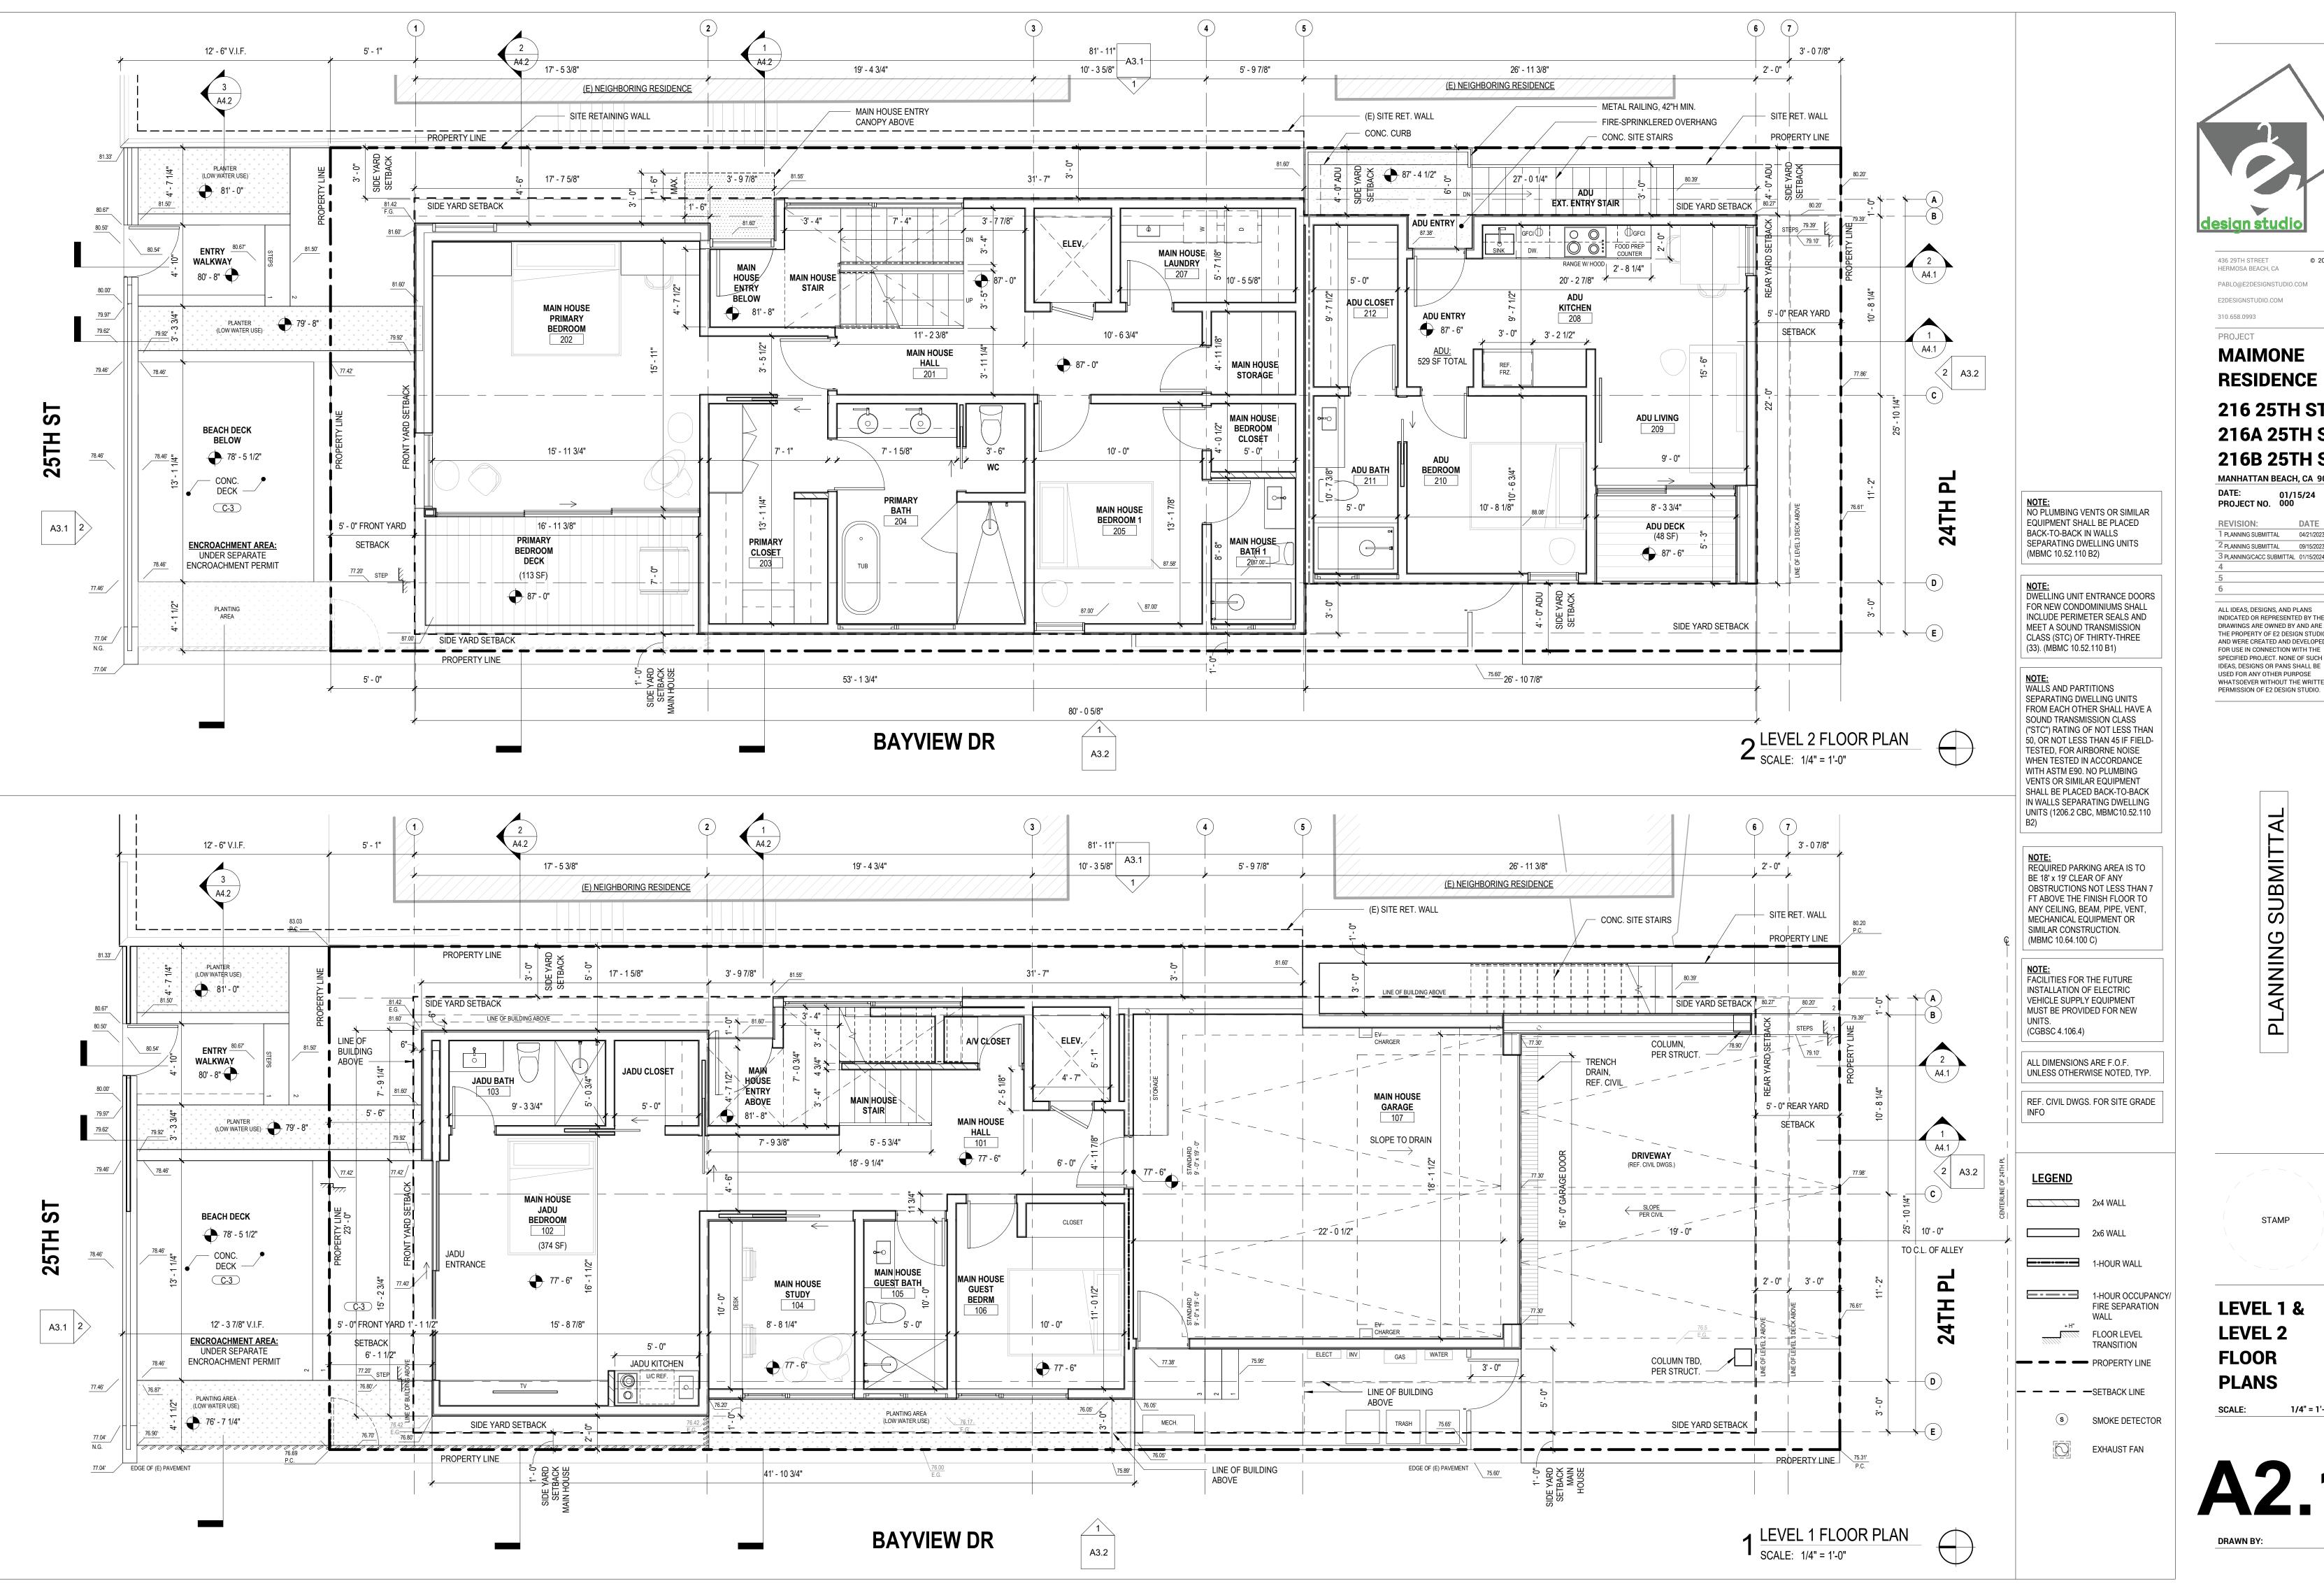
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SITE PLAN, DEMO PLAN, & AREA DIAGRAMS

A1.1

DRAWN BY:

SCALE:





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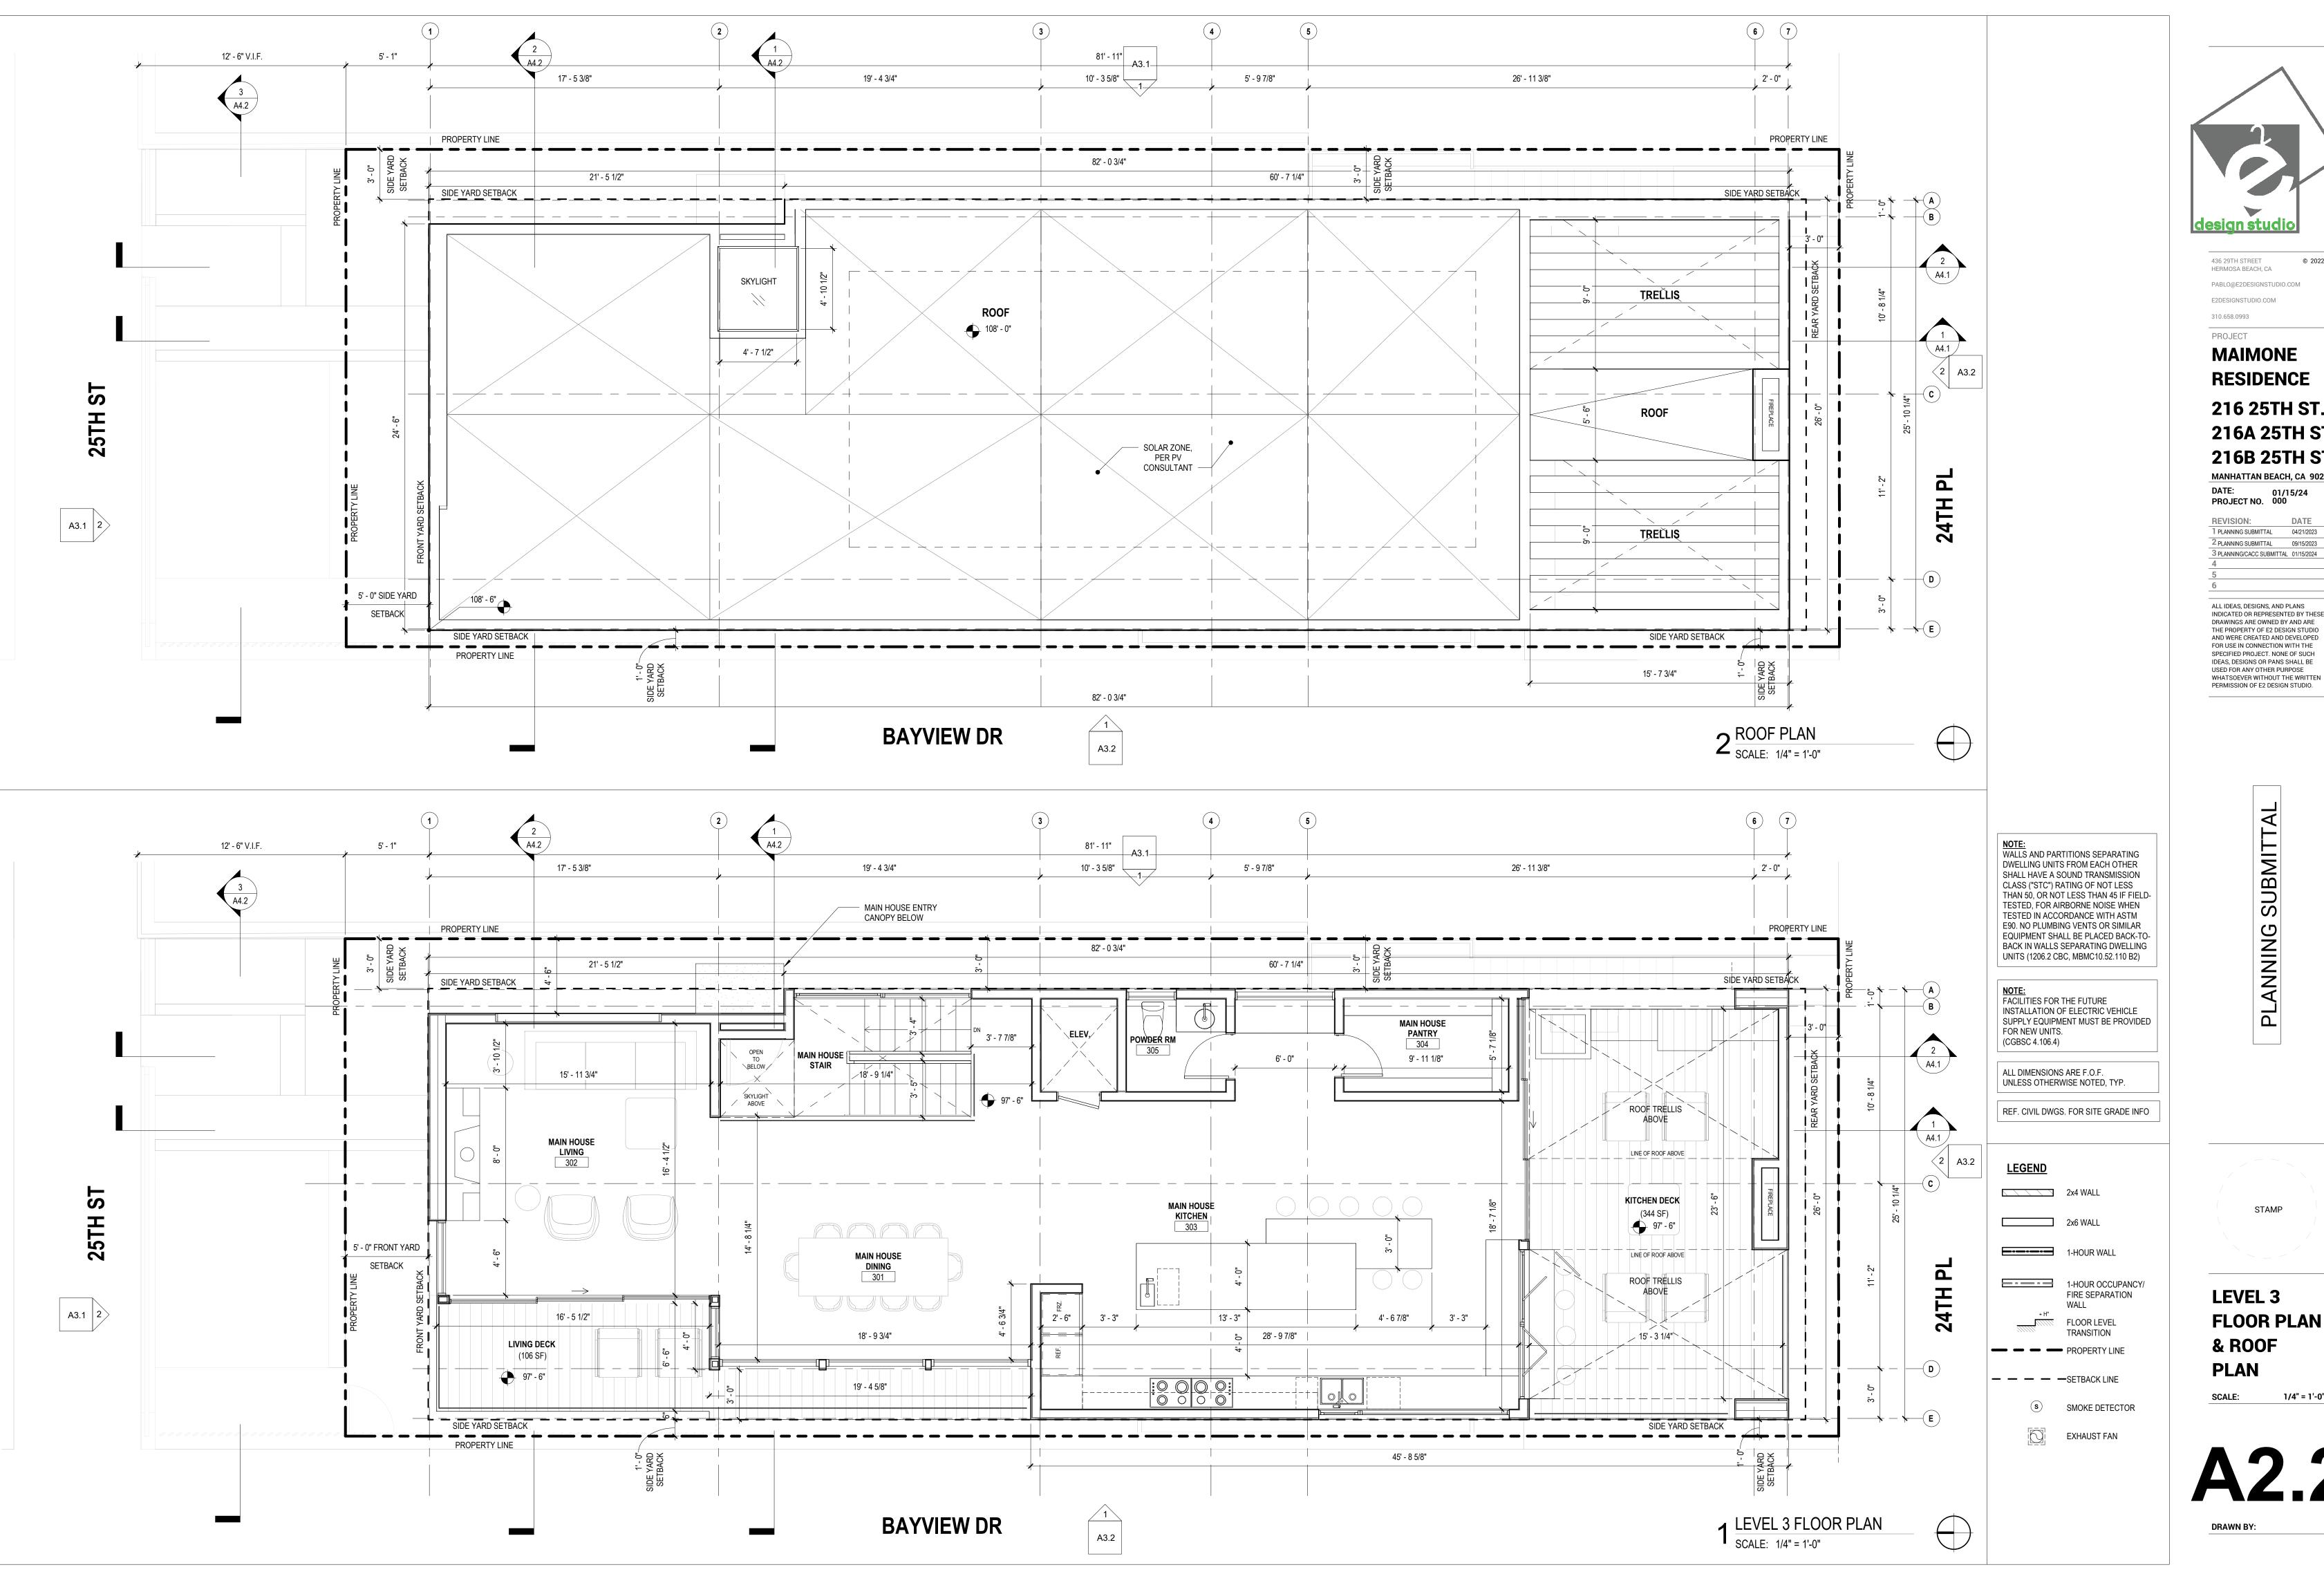
1 PLANNING SUBMITTAL 04/21/2023 2 PLANNING SUBMITTAL 09/15/2023 3 PLANNING/CACC SUBMITTAL 01/15/2024

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LEVEL 1 & LEVEL 2 **FLOOR PLANS**

SCALE: 1/4" = 1'-0"





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> SUBMITT PLANNING

STAMP

LEVEL 3 **FLOOR PLAN** & ROOF

1/4" = 1'-0"

DRAWN BY:



WHATSOEVER WITHOUT THE WRITTEN PERMISSION OF E2 DESIGN STUDIO.

EXTERIOR ELEVATIONS

UNDER SEPARATE ENCROACHMENT PERMIT 1 EAST ELEVATION
SCALE: 1/4" = 1'-0"

(WALK STREET)

LEVEL 1 CLNG 85' - 6"

(N) SOLID WOOD FENCE, 32"H MAX FOR CI

= PAINT

= STONE = TILE

WD = WOOD


42"H MAX. WD-5

MID LEVEL ENTRY
81' - 8"

PLANTER CURB

ENTRY WALK

ENCROACHMENT AREA

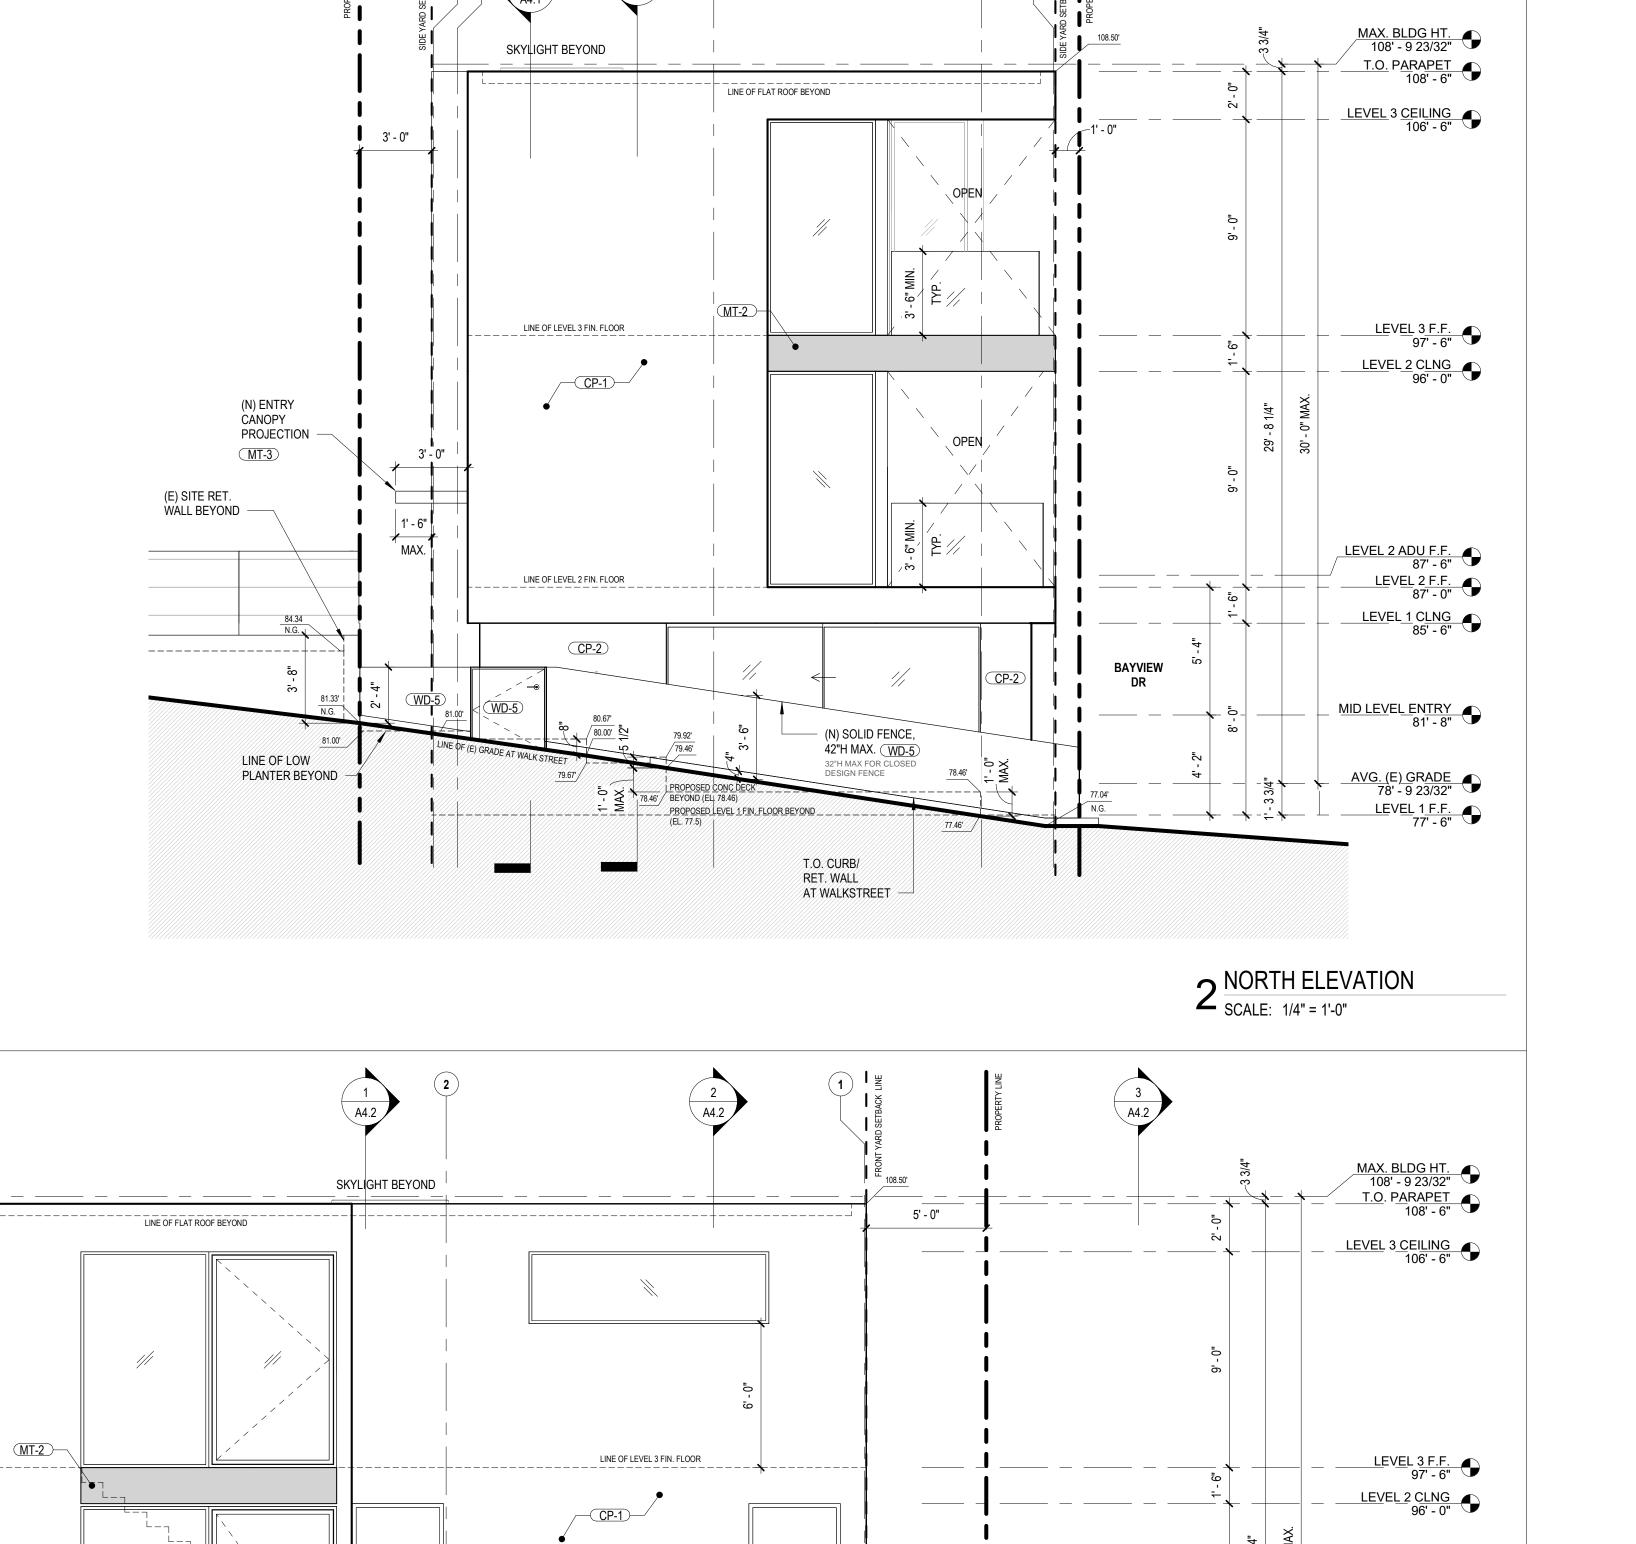

- ENTRY AWNING PROJECTION

MAIN HOUSE ENTRY

LINE OF MID-LEVEL FIN. FLOOR

LINE OF LEVEL 2 FIN. FLOOR

NING CK LINE

3' - 0" CLR.

5' - 0"_|

REAR YARD SETACK

LINE OF LEVEL 3 F.F.

CONC. SITE STAIRS

LINE OF LEVEL 2 F.F.

FIRE-SPRINKLERED OVERHANG

LINE OF LEVEL 2 F.F.

LINE OF PROPOSED GRADE

LINE OF EXISITING GRADE

- METAL RAILING, 42"H MIN.

CONC. CURB

______LINE OF LEVEL 1.F.F.

MAX. BLDG HT. 108' - 9 23/32"

T.O. PARAPET 108' - 6"

MAIMONE
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ANNING SUBMITTAL


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EXTERIOR ELEVATIONS

SCALE: As indicated

A3.2

DRAWN BY:

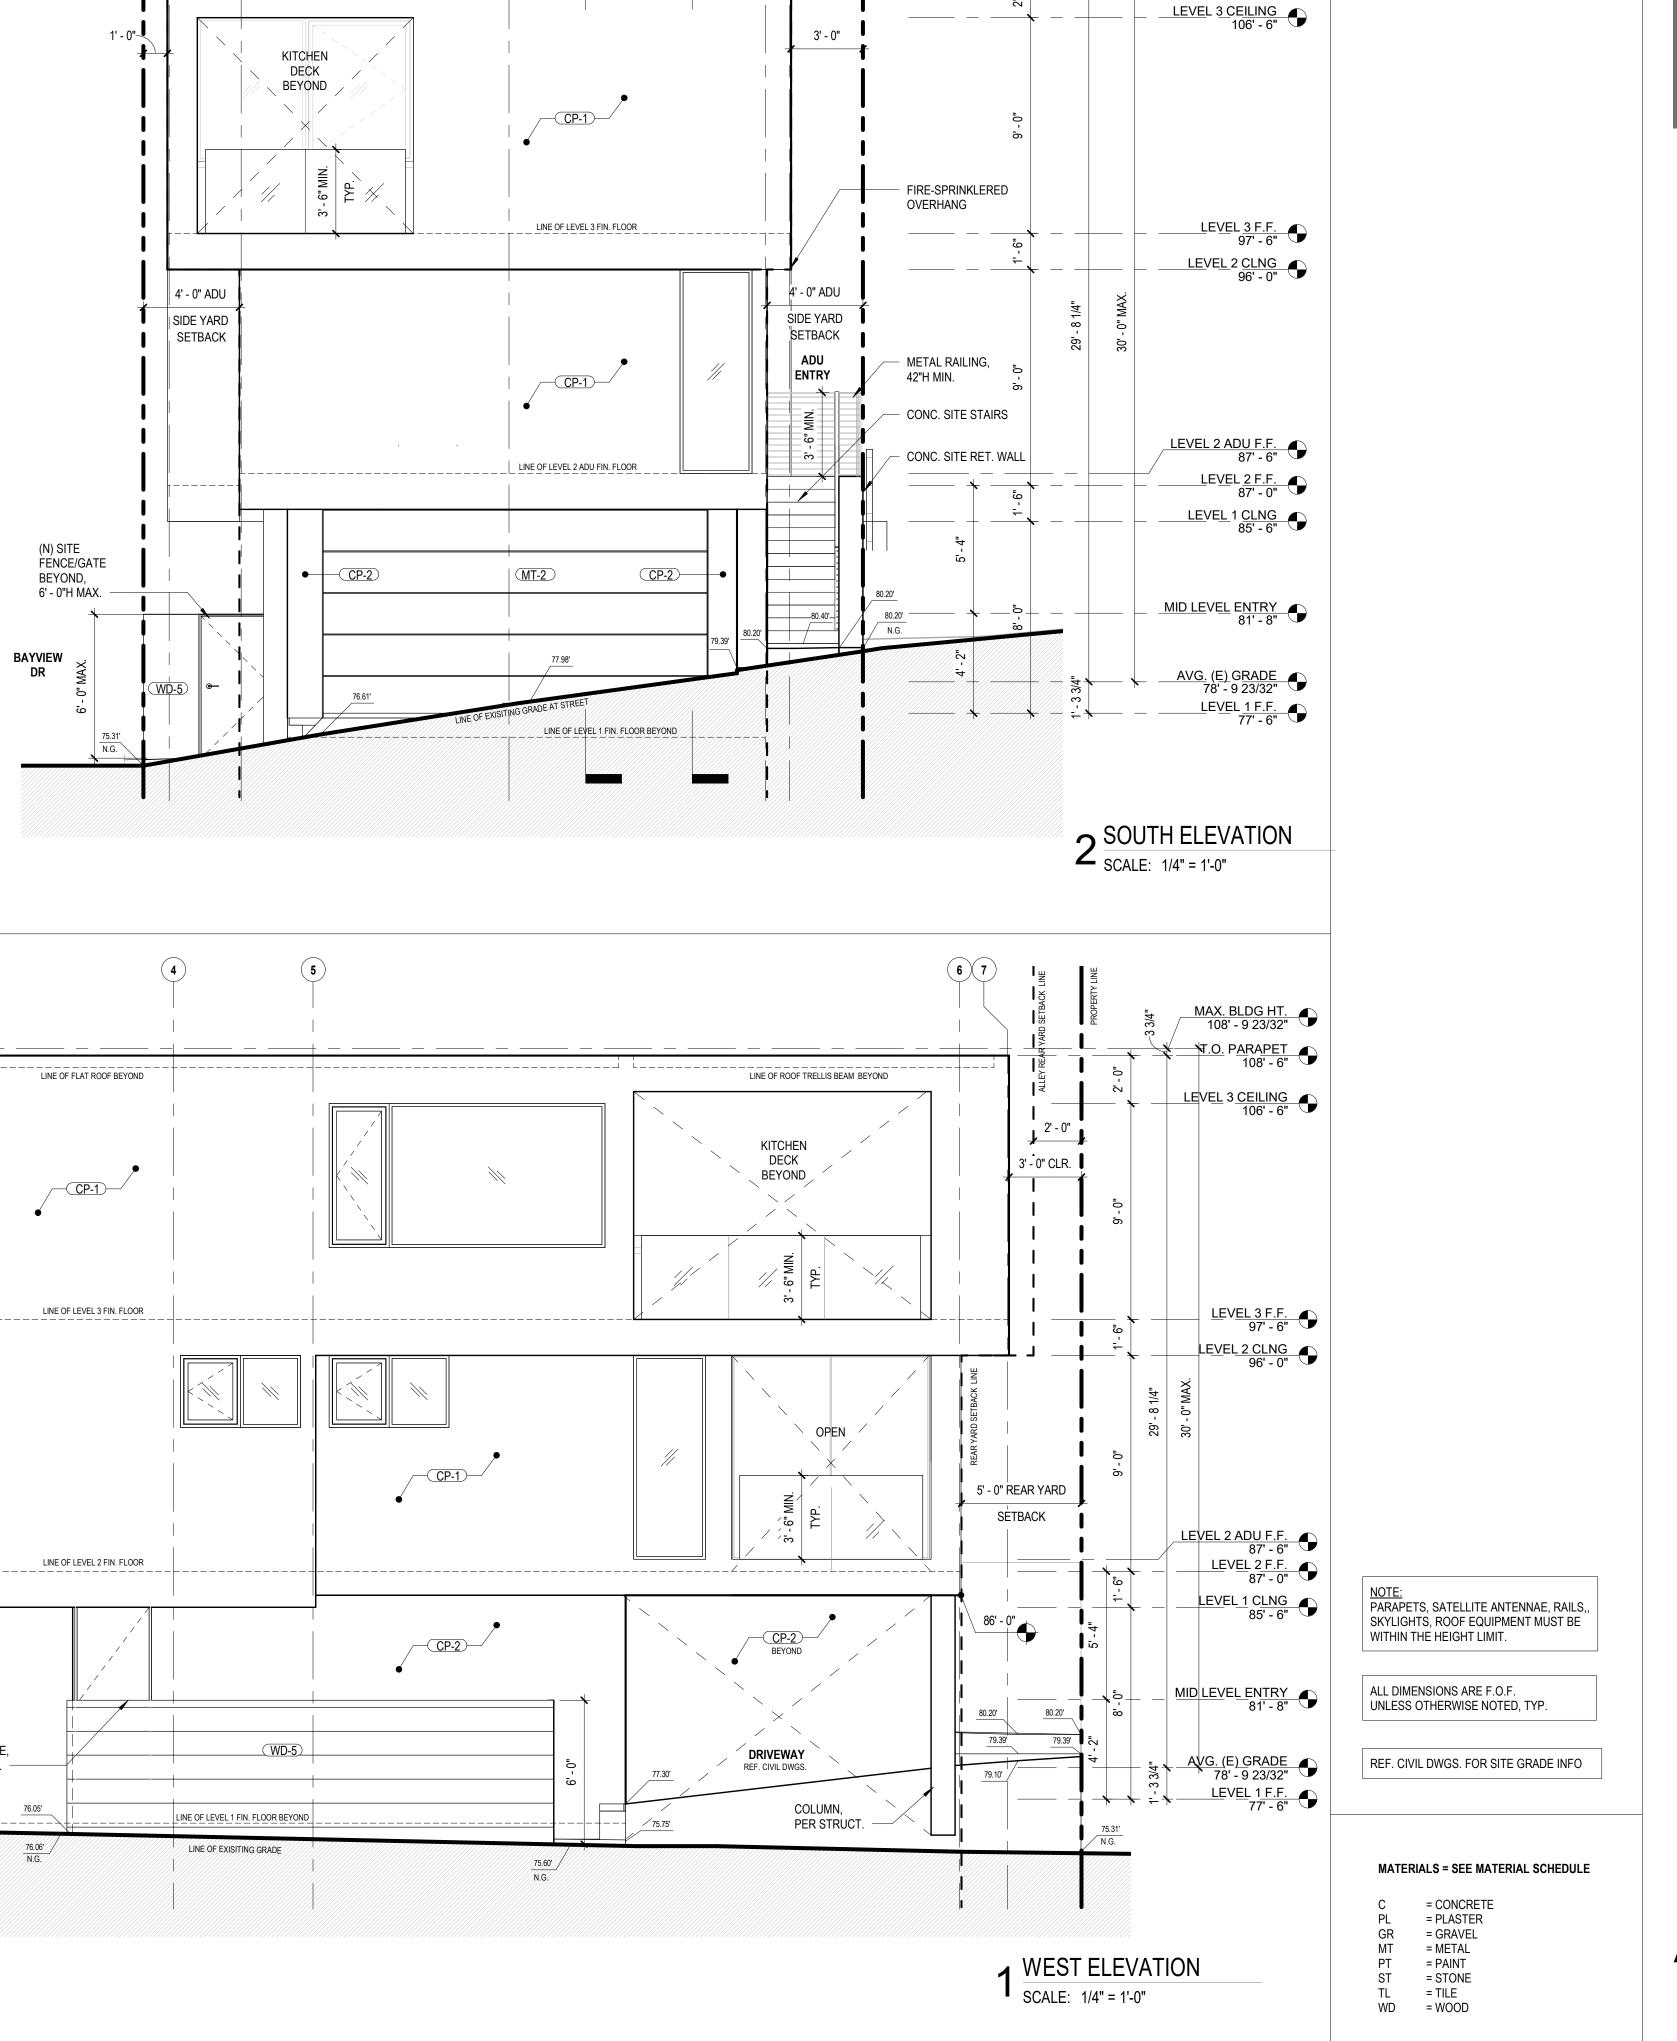

LINE OF ROOF TRELLIS BEAMS BEYOND

3

(N) SITE FENCE/GATE, 6' - 0"H MAX.

WD-5

A4.2 /

—(MT-2)

OPEN__

 (N) VERTICAL SLAT FENCE & GATE,

50% OPEN,

42"H MAX.

76.70'

A4.2

ENTRY WALK BEYOND

ENCROACHMENT AREA

UNDER SEPARATE ENCROACHMENT PERMIT

NEIGHBOR'S FENCE BEYOND

T.O. (E) RET.


32"H MAX FOR CLOSED DESIGN FENCE
(N) SOLID FENCE,
42"H MAX.

(N) VERTICAL SLAT FENCE, 50% OPEN, 42"H MAX.

WD-5

WD-6

WALL BEYOND

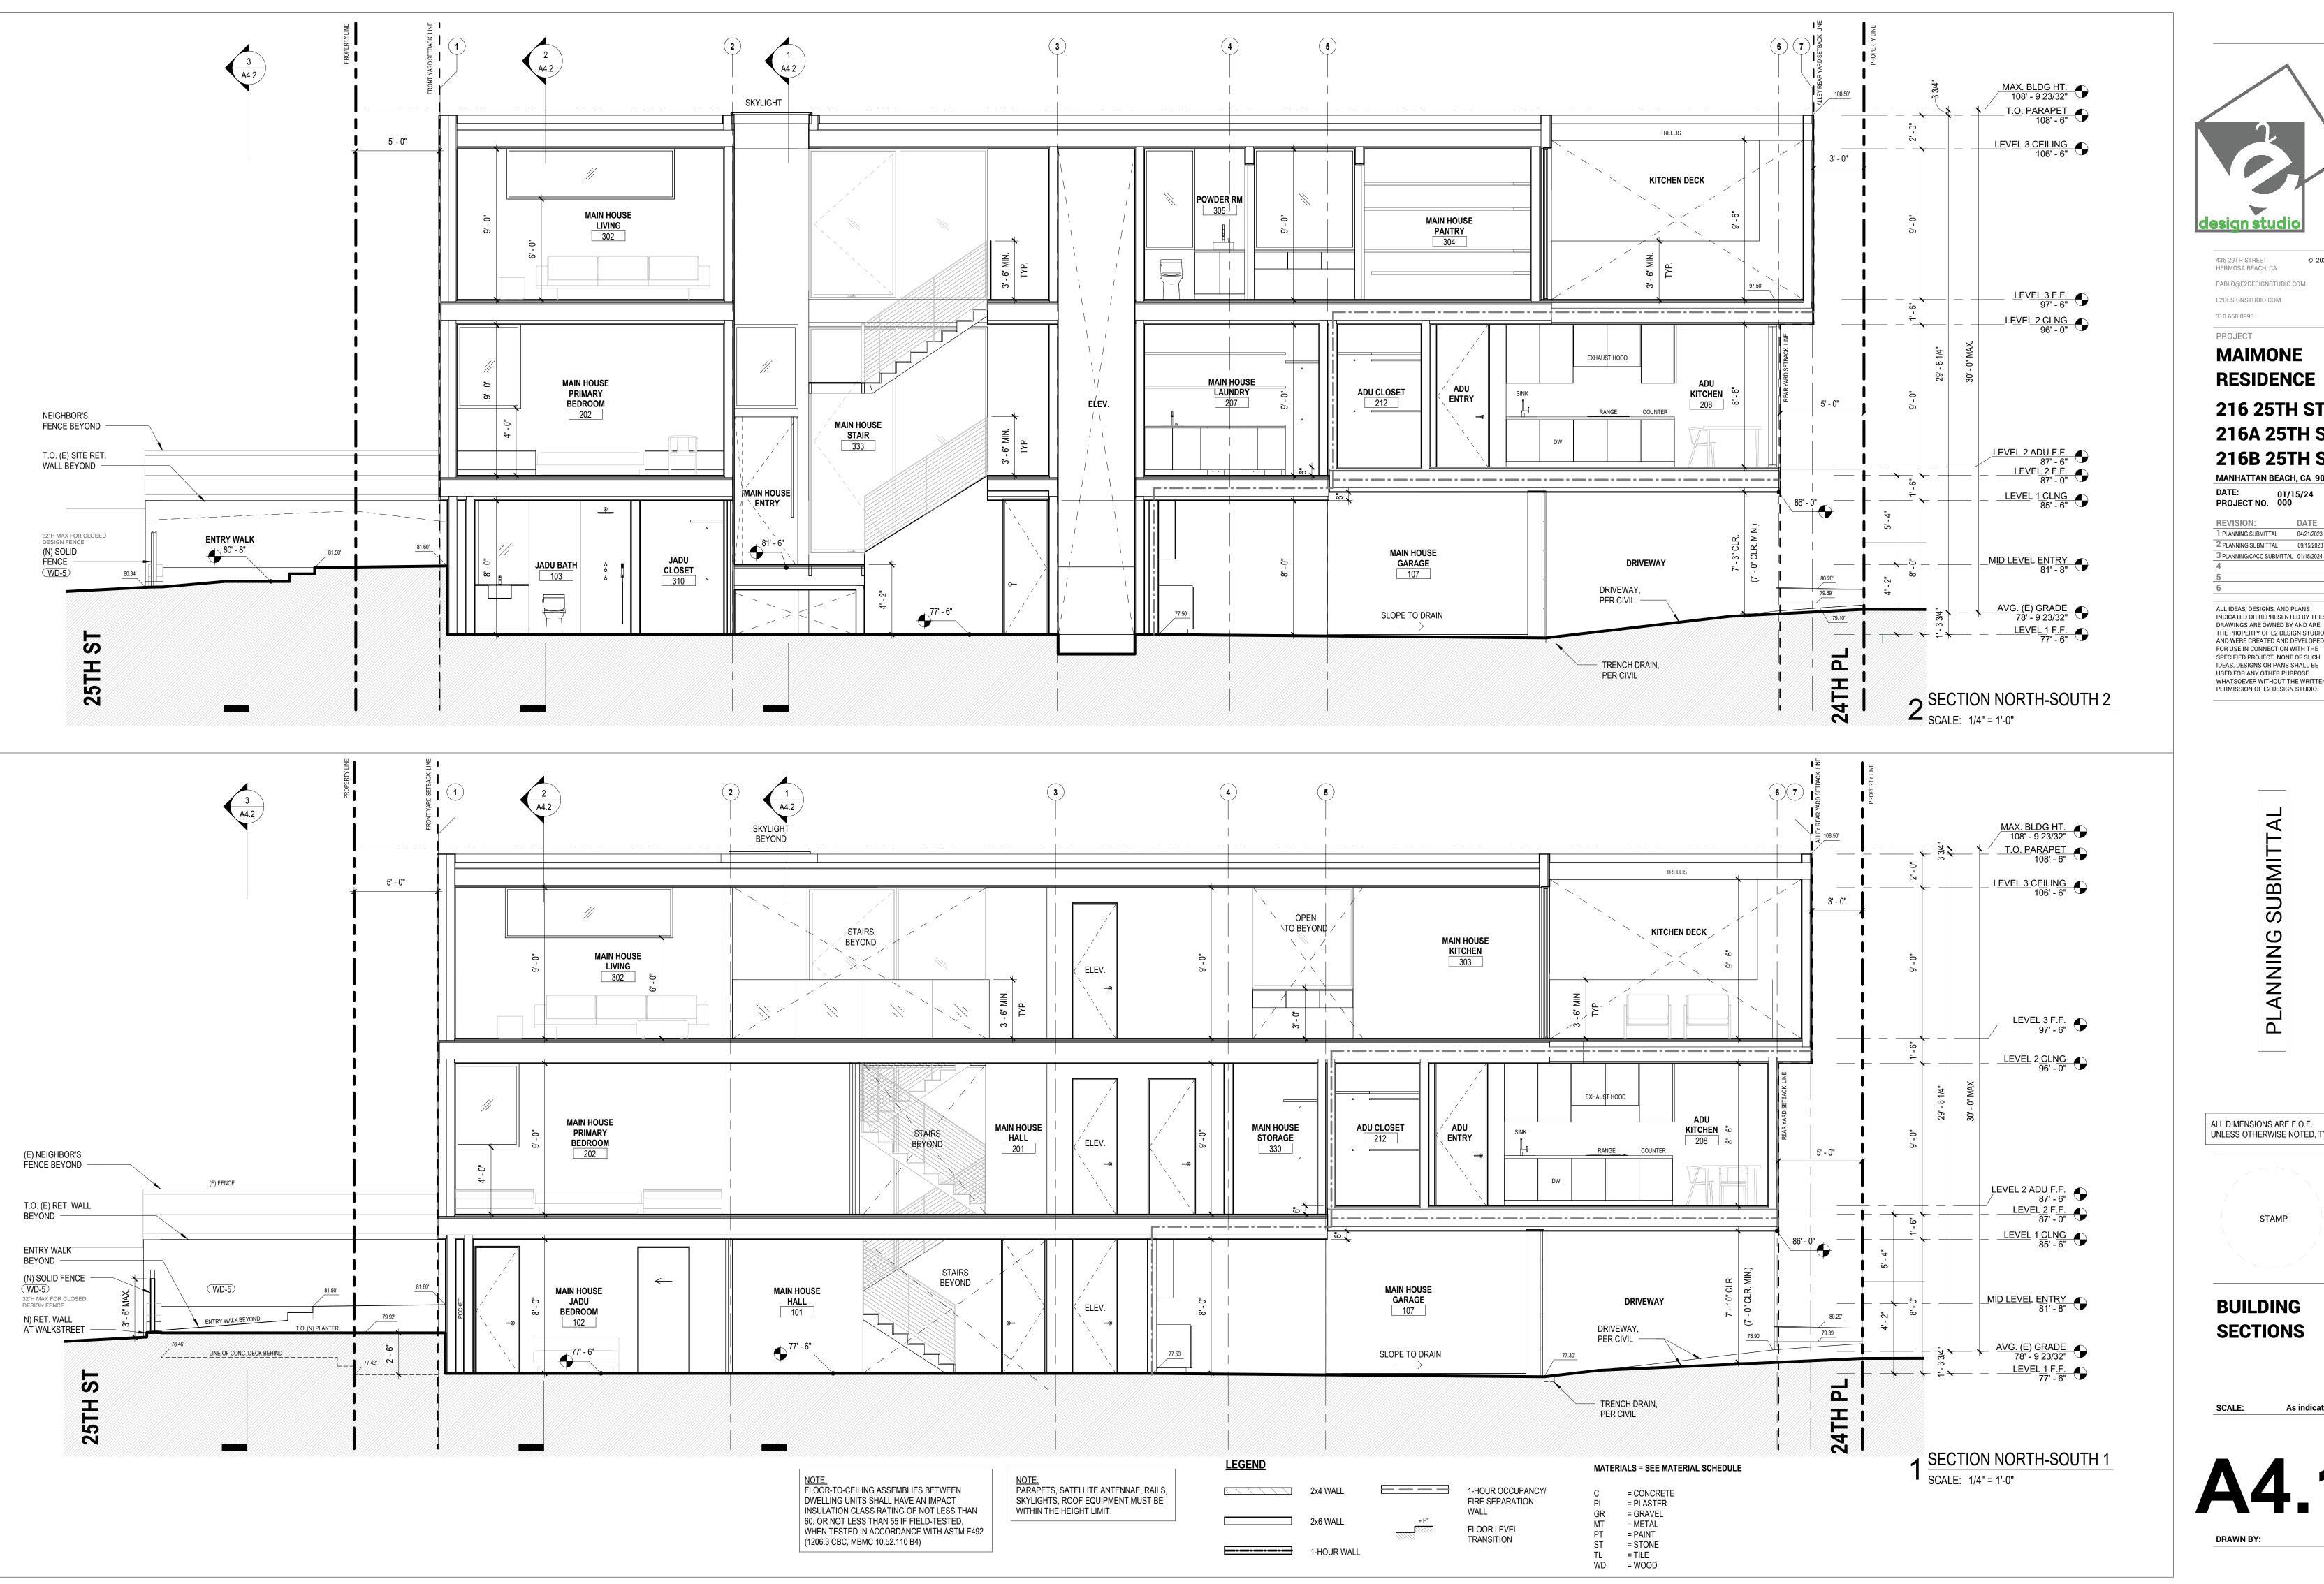

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PLANNING


ALL DIMENSIONS ARE F.O.F. UNLESS OTHERWISE NOTED, TYP.

STAMP

BUILDING

As indicated

DRAWN BY:

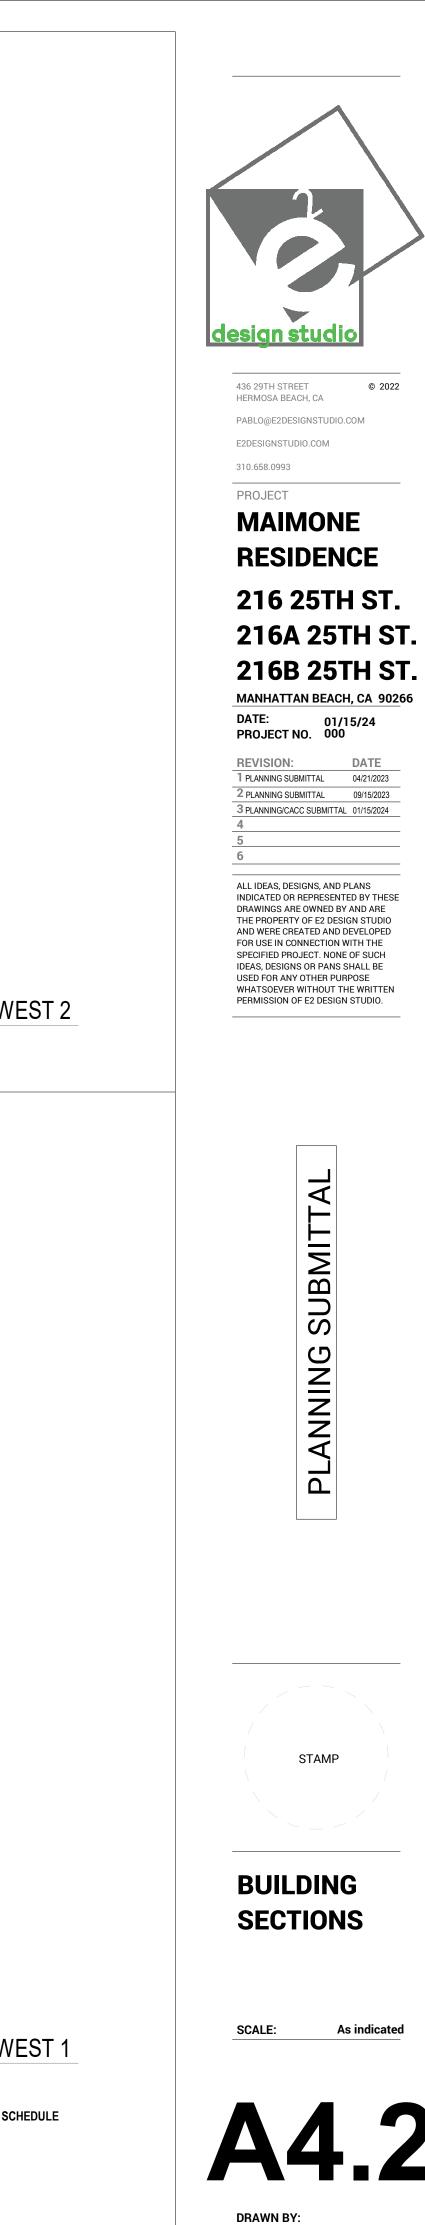

BUILDING

STAMP

SECTIONS

As indicated

MAX. BLDG HT. 108' - 9 23/32" T.O. PARAPET 108' - 6" LEVEL 3 CEILING 106' - 6" 3' - 0" LIVING DECK MAIN HOUSE LIVING 302 LEVEL 3 F.F. 97' - 6" LEVEL 2 CLNG 96' - 0" 220 25TH ST BEDROOM **MAIN HOUSE** DECK PRIMARY BEDROOM 202 (E) NEIGHBOR'S FÉNCE LEVEL 2 ADU F.F. 87' - 6" LEVEL 2 F.F. 87' - 0" LEVEL 1 CLNG 85' - 6" (E) SITE RET. WALL BAYVIEW DR MAIN HOUSE MID LEVEL ENTRY 81' - 8" JADU BEDROOM JADU BATH 102 LEVEL 1 F.F. 77' - 6" SECTION EAST-WEST 2 SCALE: 1/4" = 1'-0" T.O. PARAPET 108' - 6" SKYLIGHT MAIN HOUSE DINING 301 LEVEL 3 F.F. 97' - 6" 220 25TH ST LEVEL 2 CLNG 96' - 0" (N) ENTRY CANOPY MAIN HOUSE PRIMARY PROJECTION PRIMARY E CLOSET BEDROOM ∞ 203 (E) NEIGHBOR'S FENCE LEVEL 2 ADU F.F. 87' - 6" / (E) SITE RET. WALL LEVEL 2 F.F. 87' - 0" , MAIN HOUSE, LEVEL 1 CLNG 85' - 6" ENTRY BAYVIEW DR MAIN HOUSE STUDY 104 MID LEVEL ENTRY 81' - 8" |||MAIN HOUSE HALK Y ■ SECTION EAST-WEST 1 SCALE: 1/4" = 1'-0" <u>LEGEND</u> MATERIALS = SEE MATERIAL SCHEDULE NOTE: FLOOR-TO-CEILING ASSEMBLIES BETWEEN DWELLING UNITS SHALL HAVE AN IMPACT NOTE:
PARAPETS, SATELLITE ANTENNAE, RAILS,
SKYLIGHTS, ROOF EQUIPMENT MUST BE 1-HOUR OCCUPANCY/ FIRE SEPARATION = CONCRETE = PLASTER = GRAVEL = METAL = PAINT INSULATION CLASS RATING OF NOT LESS THAN 60, OR NOT LESS THAN 55 IF FIELD-TESTED, WITHIN THE HEIGHT LIMIT. FLOOR LEVEL WHEN TESTED IN ACCORDANCE WITH ASTM E492 TRANSITION (1206.3 CBC, MBMC 10.52.110 B4) = STONE 1-HOUR WALL TL = TILE WD = WOOD

