
	ABBRE	EVIATIONS		SYMBOLS	BUILDING CODES	PROJECT DIRECTORY	
AB ABS A/C AFF AFG ACST ACOUS ADJ ALUM ACI ADA ADDL AHU AISC ALT AMP ANCH APT APPROX ARCH ASTM ATTEN AWI BD BR BITUM BLDG BLK(G) BM BOD BOF BOS BOS BOW BSMT BTH RM BTU CAB CER	ANCHOR BOLT ACRYLONITRILE BUTADIENE STYRENE AIR CONDITIONING ABOVE FINISH FLOOR ABOVE FINISH FLOOR ABOVE FINISH GRADE ACOUSTICAL ACOUSTIC / ACOUSTICAL ADJACENT / ADJUSTABLE ALUMINUM AMERICAN CONCRETE INSTITUTE AMERICAN SWITH DISABILITIES ACT ADDITIONAL AIR HANDLING UNIT AMERICAN INSTITUTE OF STEEL CONSTRUCTION ALTERNATE(TIVE) AMPERAGE ANCHOR APARTMENT APPROXIMATELY ARCHITECT / URAL AMERICAN STANDARDS OF TESTING AND MATERIALS ATTENUATION ARCHITECTURAL WOODWORKING INSTITUTE BOARD BEDROOM BITUMINOUS BUILDING BLOCK / BLOCKING BEAM BOTTOM OF BASIS OF DESIGN BOTTOM OF SLAB BOTTOM OF SLAB BOTTOM OF WALL BASEMENT BATHROOM BRITISH THERMAL UNIT CABINET CATCH BASIN CERAMIC	LB(S) LEV LF LH LHR LSCAPE LOC LR LTG LVL MACH RM MAG MATL MAX MB MC MECH MEP MEZZ MFR MTL MIN MIN MIN MIN MIN MIN MIN MIN MIN MIN	POUND(S) LEVEL LINEAL FOOT LEFT HAND REFT HAND REVERSE LANDSCAPE LOCATION LIVING ROOM LIGHTING LAMINATED VENEER LUMBER MACHINE ROOM MAGNET(IC) MATERIAL MAXIMUM MAILBOX MEDICINE CABINET MECHANICAL MEMBRANE MECHANICAL, ELECTRICAL, PLUMBING MEZZANINE MANUFACTURE(R),(D) METAL MINIMUM, MINUTE MISCELLANEOUS MASONRY OPENING METAL MULLION MULTIPLE NEW NORTH NOT APPLICABLE NEIGHBORING GRADE NOT IN CONTRACT NUMBER NOMINAL NOT TO SCALE OVER OVER OVER OVER OVER OVERFLOW	$\frac{3}{E}$ NEW GRIDLINES $\frac{3}{E}$ EXISTING BUILDING GRIDLINES $\frac{3}{E}$ EXISTING BUILDING GRIDLINES $\frac{1}{E}$ NORTH ARROW $\frac{1}{4300}$ BUILDING ELEVATION DRAWING NUMBER SHEET NUMBER $\frac{1}{4400}$ BUILDING SECTION DRAWING NUMBER SHEET NUMBER $\frac{1}{4500}$ WALL SECTION DRAWING NUMBER SHEET NUMBER	2022 CALIFORNIA BUILDING CODE 2022 CALIFORNIA RESIDENTIAL CODE 2022 CALIFORNIA GREEN BUILDING STANDARDS CODE 2022 CALIFORNIA MECHANICAL CODE 2022 CALIFORNIA ELECTRICAL CODE 2022 CALIFORNIA ELECTRICAL CODE 2022 CALIFORNIA PLUMBING CODE 2022 CALIFORNIA BUILDING ENERGY EFFICIENCY STANDARDS CODE MANHATTAN BEACH MUNICIPAL CODE	OWNER SCOTT MAXWELL SCOTT @OV/VC       STRUCTURAL ENGINEER LFA STRUCTURAL 319 MAIN STREET       ENERGY/ITILE 24 NEWTON ENERGY 1730 E HOLLY AVE, EL SEGUNDO, CA 90245         ARCHITECT LAREY LAINC 725 CYPRESS AVE HERMOSA BEACH, CA 90254 (310) 970-7175       ENERGY/ITILE 24 LS SEGUNDO, CA 90245         OWNER SCOTT ARCHITECT NAME@JANEYLA       SA SIMS ENGINEERING, INC. 1341 DRIZABA AVE LONG BEACH, CA 90304 (562) 735-4955       ENERGY/ITILE 24 NEWTON ENERGY@GMAIL.COM         SURVEY DENN ENGINEERS 3914 DEL AMO BL/D, SUITE 921 TORRANCE, CA 90503 (3010 542 9433       WWW BASIMS.COM         GEO-TECHNICAL ENGINEER NORCAL ENGINEERINS 10641 HUMBOLT STREET LOS ALAWITOS, CA 90720 (562) 799-9469       STRUCTURAL ISA SIMS AND INC. 1341 DRIZABA AVE       STRUCTURAL ISA SIMS AND INC. 1341 DRIZABA AVE	
CFM CFOI CH CJ CJ CL CLG CLG CLG CLR CMU CO COL CONC CONST CONT COORD CPT CSMT	CUBIC FEET PER MINUTE CONTRACTOR FURNISHED; OWNER INSTALLED CHANNEL CAST-IN-PLACE CEILING JOIST CONTROL JOINT CENTER LINE CEILING CLOSET CLEAR CONCRETE MASONRY UNIT CLEAN OUT COLUMN CONCRETE CONSTRUCTION CONSTRUCTION CONTINUOUS COORDINATE / ION CARPET(ED) CASEMENT	OVHD OVHG PBD PC PED PERF PERIM PERP PH PL PLAM PLT PLAS PLWD POL PR PREFAB PREFAB PREFAB	OVERHEAD OVERHANG PARTICLE BOARD PROPERTY CORNER PEDESTAL PERFORATED PERIMETER PERMANENT PERPENDICULAR PHASE PROPERTY LINE PLASTIC LAMINATE PLASTER PLATE PLASTER PLYWOOD POLISHED PAIR PREFABRICATED PRELIMINARY	A4 A700 A2 INTERIOR ELEVATION DRAWING NUMBER SHEET NUMBER 1 A900 DETAIL - SECTION DRAWING NUMBER SHEET NUMBER DETAIL - CLOUD DRAWING NUMBER SHEET NUMBER	- ELECTRICAL - PLUMBING -POOL -HANDRAILS / GUARD (1607.8) RENNOVATION LEGEND EXISTING ELEMENT DEMOLISHED ELEMENT NEW ELEMENT	SHEET INDEX         COVER SHEET & GENERAL INFO         G01       COVER SHEET         G02       GENERAL NOTES         G03       CODE DIAGRAMS         SURVEY - MAPPING         V01       SURVEY PLAN	PROJECT ADD MAIN RESIDEN 304 THE STRAM MANHATTAN BI 306 THE STRAM MANHATTAN BI LEGAL DESCR MANHATTAN BI APN: 4180.022.004
CSMI CT CU D dB DBL °or DEG DEPT DIAG Ø or DIA DIM DN DR DS DTL DW DWG DWR (E) E EA EIFS ELECT ELEV ENCL ENGR EP EQ EQUIP ESMT EST EXP EXT	CASEMENT CERAMIC TILE CUBIC "DRYER; DEEP" DECIBEL DOUBLE DEGREE DEPARTMENT DIAGONAL DIAMETER DIMENSION DOWN DOOR / DINING ROOM DOWNSPOUT DETAIL DISHWASHER DRAWING DRAWER EXISTING EAST EACH EXTERIOR INSULATION AND FINISH SYSTEM ELECTRICAL "ELEVATOR; ELEVATION" ENCLOSURE ENGINEER ELECTRICAL PANEL EQUAL EQUIPMENT EASEMENT ESTIMATE EACH WAY EXHAUST EXTERIOR	PRELIM PRI PRKG PROJ PROP PSF PSI PSL PT TREATED" PTD PTD PTN PVA PVC PVG PWT QTY R RCP RD RO RCP RD RO RAD REC REF REINF REQ'D RES RESIL RET REV RH RHR RM RO RO RO RO RO RO RO RO RO RO RO RO RO	PRELIMINARY PRIMARY PARKING PROJECT PROPERTY POUNDS PER SQUARE FOOT POUNDS PER SQUARE INCH PARALLEL STRAND LUMBER "POST/PRE TENSION, PRESSURE PAINT(ED) PARTITION POLYVINYL ACRYLIC POLYVINYL CHLORIDE PAVING PORCELAIN WALL TILE QUANTITY "RADIUS, RISER" REFLECTED CEILING PLAN "ROOF DRAIN, ROAD" ROUGH OPENING RADIUS RECESSED "REFER(ENCE), REFRIGERATOR" REINFORCE(D),(ING) REQUIRED RESISTANT RESISTANT RESISTANT RESILIENT RETAINING "REVERSE, REVIS(ED),(ION)" "RIGHT HAND, ROOF HATCH" RIGHT HAND REVERSE ROOM ROUGH OPENING RIGHT-OF-WAY REVOLUTIONS PER MINUTE	<ul> <li>+144.25' SPOT ELEVATION</li> <li>+144.25' DATUM / DIMENSION / CONTROL POINT</li> <li>MATCHLINE SEE XX/AXXX</li> <li>MATCHLINE DRAWING SHEET SHOW'G ADJ CONDITION</li> <li>CONTOURS EXISTING CONTOURS REVISED CONTOURS</li> <li>PROPERTY LINE</li> <li>PROPERTY LINE</li> <li>DASHED LINE INDICATES HIDDEN, OVERHEAD, OR DEMO'D ITEMS</li> <li>CENTERLINE</li> <li>MATCHLINE DASHED LINE INDICATES HIDDEN, OVERHEAD, OR DEMO'D ITEMS</li> </ul>	MATERIAL LEGEND         ALUMINUM         ASHLAR STONE         BRICK FACE/COMMON         CEMENTITIOUS UNDERLAYMENT         CONCRETE         CONCRETE         CONCRETE MASONRY UNIT         EARTH, COMPACTED FILL         GRAVEL FILL         GRAVEL FILL         GROUT/SAND	V01       SURVET PLAN         LANDSCAPE         L01       LANDSCAPE PLAN         SITE PLAN         A101       SITE PLAN         FLOOR PLANS         A201       1ST FLOOR PLAN         A202       2ND FLOOR PLAN         A203       3RD FLOOR PLAN         A204       ROOF PLAN         A201       SOUTH ELEVATION         A301       SOUTH ELEVATION         A303       EAST ELEVATION	4180-022-004 ZONING: RM AREA DISTR OCCUPANCY G R3+U CONSTRUCTION TYPE V-B LOT AREA (NET 3,336 SF BUILDABLE FLO 3,336 SF x (1.6) OPEN SPACE: 3599 X 0.15 = 54
FAM FAU FD FDN FE FFHB FIN FG FIXT FFE FL FLR FLUOR FO FOC FOF FOIC FOIC FOIC FOIO FOM FOP FOS FPL FRMG FRT FT FT G FURN FV	FLUID-APPLIED-MEMBRANE FORCED AIR UNIT FLOOR DRAIN FOUNDATION FIRE EXTINGUISHER FROST-FREE HOSE BIB FINISH(ED) FINISH GRADE FIXTURE FINISH FLOOR ELEVATION FLOWLINE FLOOR FLUORESCENT FACE OF FACE OF CONCRETE FACE OF FINISH FURNISHED BY OWNER INSTALLED BY CONTRACTOR FURNISHED BY OWNER; INSTALLED BY OWNER; INSTALLED BY OWNER; FACE OF MASONRY FACE OF PLYWOOD FACE OF STUD FIREPLACE FRAMING FIRE-RETARDANT TREATED FOOT / FEET FOOTING FURNITURE FIELD VERIFY	RT RTU S SAM SC SCHED SD SECT SF SFR SHT SIM SP SPEC(S)(D) SPKLR SQ SQ IN SS SSM SW ST STC STD STL STCR STL STCR STL STCR STRUCT SUSP SV SYM T T&G	RIGHT ROOFTOP UNIT SOUTH SELF-ADHERING MEMBRANE SOLID CORE SCHEDULE STORM DRAIN SECTION SQUARE FOOT/FEET SINGLE-FAMILY RESIDENCE SHEET SIMILAR STANDPIPE SPECIFICATION(S) / SPECIFIED SPRINKLER SQUARE INCH STAINLESS STEEL STANDING SEAM SANITARY SEWER "STAIRS, STREET" SOUND TRANSMISSION CLASS STANDARD STEEL STORAGE STRUCTURAL SUSPEND(ED) SHEET VINYL SYMMETRICAL TREAD TONGUE AND GROOVE	APPP-01APPLIANCE / FIXTURE TAGW01AASSEMBLY TAG (WALL, FLOOR, CEILING, ROOF)101.2DOOR TAGPL-01FINISH TAG101ROOM TAG101.AWINDOW TAG101.AREVISION TAG / REVISION CLOUD	INSULATION, BATT INSULATION, BATT INSULATION RIGID INSULATION, SPRAY FOAM ORIENTED STRAND BOARD PARTICLE BOARD PLYWOOD STEEL, OTHER METALS WOOD, BLOCKING OR SHIM WOOD, FINISHED WOOD, FRAMING WOOD, GLUE-LAMINATED	A304 WEST ELEVATION          SECTIONS - ARCH         A401       BUILDING SECTIONS         A402       BUILDING SECTIONS	DESCRIP INSIDE FOOTP 1ST FLOOR: 2ND FLOOR: 3RD LEVEL: GARAGE: DECKS OVER 3 DECKS OVER 3 DECKS OVER 3 DECKS OVER 3 DECKS OVER 3 DESCI PARCEL NUMB PROJECT ADD NO. OF STORIE TYPE OF CONS CODE CYCLE: OCCUPANT US AUTOMATIC FI
G GA GA MANUAL GAL GALV GB GC GEN GL ULAM GOVT GSM GRD GWB GYP HB HD HDR HDW HDW HDW HDW HDW HDW HDW HDW HDR HR HSS HT HVAC HW IBC ID IE IIC IN INSUL INT JST KIT KW L LAM LAT LAV	NATURAL GAS GAUGE GYPSUM ASSOCIATION MANUAL GALLON "GALVANIZED, GALVANIC" GRAB BAR GENERAL CONTRACTOR GENERAL GLASS GLUE LAMINATED WOOD GOVERNMENT GALVANIZED SHEET METAL GRADE GYPSUM WALL BOARD GYPSUM HOSE BIB HOLDDOWN HEADER HARDWARE HARDWOD HOLLOW METAL HOUR HOLLOW STRUCTURAL SECTION HEIGHT HEATING, VENTILATION, AIR CONDITIONING HOT WATER HEATER INTERNATIONAL BUILDING CODE INSIDE DIAMETER / INTERIOR DESIGN INVERT ELEVATION IMPACT ISOLATION CLASS INCH INSULATION INTERIOR JOIST(S) KITCHEN KILOWATT LENGTH LAMINATE(D) LATERAL LAVATORY	TBD TELE TEMPORARY" TFF THK THRU TO TOB TOC TOF TOW TV TYP UL UNO UTIL URM V VCT VERT VIF VOL W W/ W/ W/D W/ W/ W/D W/ W/ W/D W/ W/ W/ W/ W/ W/ W/ W/ W/ W/ W/ W/ W/	TO BE DETERMINED TELEPHONE "TEMPERATURE, TEMPERED, TOP OF FINISH FLOOR THICK(NESS) THROUGH TOP OF FOR TOP OF BEAM "TOP OF CONCRETE, CURB" TOP OF FINISH TOP OF WALL TELEVISION TYPICAL UNDERWRITERS LABORATORIES UNLESS NOTED OTHERWISE UTILITY UNREINFORCED MASONRY VOLT VINYL COMPOSITE TILE VERTICAL VERIFY IN FIELD VOLUME "WEST, WIDTH, WASHER" WITH WASHER & DRYER WITHIN WITHOUT WATER CLOSET WIDE FLANGE "WATERPROOF, WEATHERPROOF" WOOD WINDOW WEATHER RESISTIVE BARRIER WEIGHT YARD AND ANGLE AT NUMBER PLUS OR MINUS	404			SYSTEM TYPE: SPECIAL COND DESCF INSIDE FOOTPI 1ST FLOOR: 2ND FLOOR: 3RD FLOOR: GARAGE: DECKS OVER 3

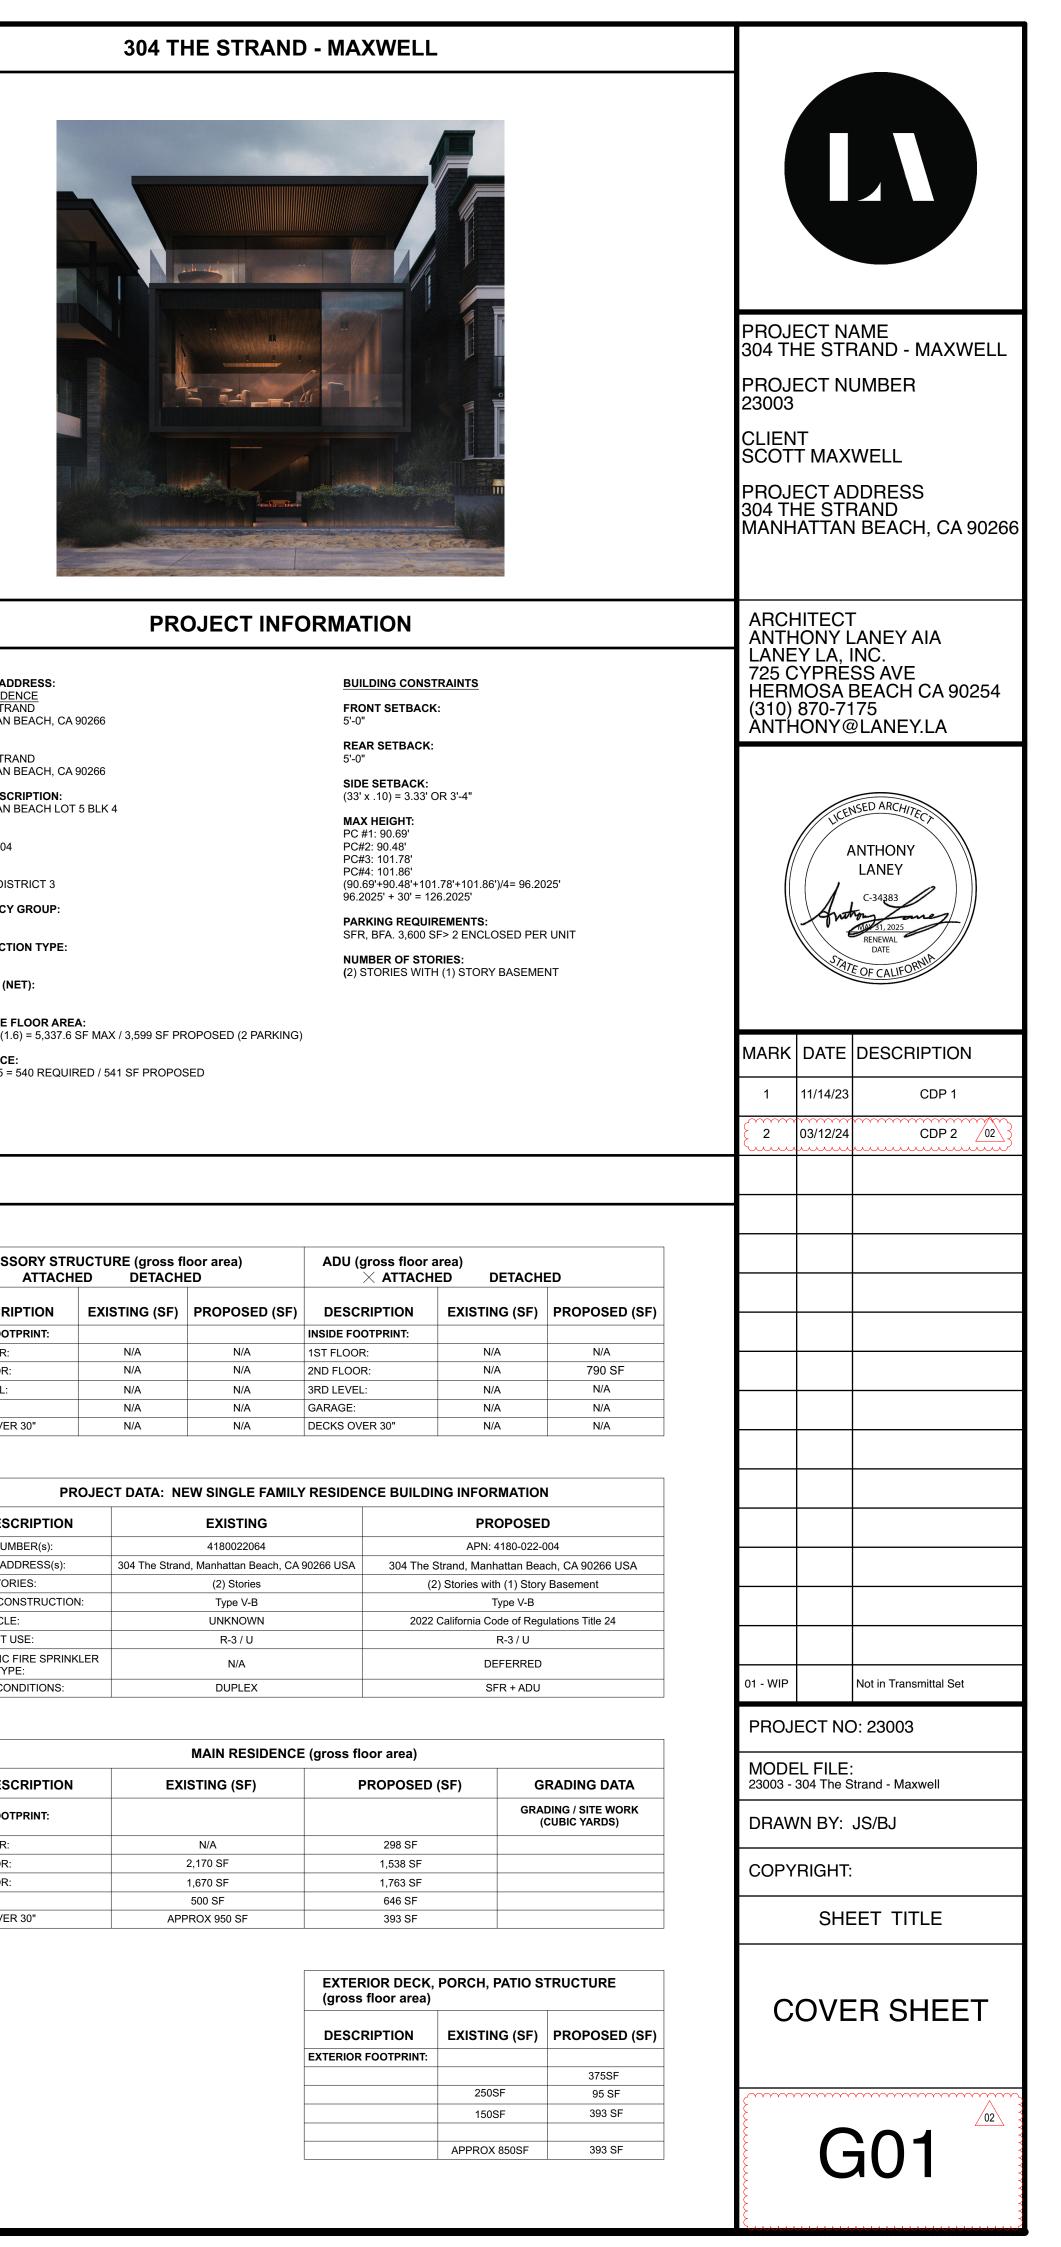

#### **PUBLIC WORKS**

1) BACK FLOW DEVICES: ALL LANDSCAPE IRRIGATION BACK FLOW DEVICES MUST MEET CURRENT CITY REQUIREMENTS FOR PROPER INSTALLATION

2) WASTE REMOVAL: NO DISCHARGE OF CONSTRUCTION WASTEWATER, BUILDING MATERIALS, DEBRIS, OR SEDIMENT FROM THE SITE IS PERMITTED. NO REFUSE OF ANY KIND GENERATED ON A CONSTRUCTION SITE MAY BE DEPOSITED IN RESIDENTIAL, COMMERCIAL, OR PUBLIC REFUSE CONTAINERS AT ANY TIME. THE UTILIZATION OF WEEKLY REFUSE COLLECTION SERVICE BY THE CITY'S HAULER FOR ANY REFUSE GENERATED AT THE CONSTRUCTION SITE IS STRICTLY PROHIBITED. FULL DOCUMENTATION OF ALL MATERIALS/TRASK LANDFILLED AND RECYCLED MUST BE SUBMITTED TO THE PERMITS DIVISION IN COMPLIANCE OF THE CITY'S CONSTRUCTION AND DEMOLITION RECYCLING ORDINANCE.

3) SEWER CLEANOUT: A PROPERTY LINE CLEANOUT MUST BE INSTALLED ON A 6-DEGREE SANITARY SEWER LATERAL. IF THERE IS NO 6-DEGREE LATERAL, THEN A NEW ONE MUST BE INSTALLED WITHIN THE PROPERTY LINES. SEE THE LOCAL PUBLIC WORKS DEPARTMENT FOR TYPICAL CONSTRUCTION DETAILS.

4) BACKWATER VALVE: A BACKWATER VALVE IS REQUIRED ON THE SANITARY SEWER LATERAL IF THE DISCHARGES FROM FIXTURES WITH FLOOD-LEVEL RIMS ARE LOCATED BELOW THE NEXT UPSTREAM MANHOLE COVER OF THE PUBLIC SEWER. SEE THE LOCAL PUBLIC WORKS DEPARTMENT FOR TYPICAL CONSTRUCTION DETAILS.

5) EXISTING SEWER LATERAL: IF AN EXISTING SEWER LATERAL IS USED, IT MUST BE TELEVISED TO VERIFY ITS STRUCTURAL INTEGRITY. THE TAPE MUST BE MADE AVAILABLE FOR REVIEW BY THE PUBLIC WORKS DEPARTMENT. THE LOCAL PUBLIC WORKS DEPARTMENT WILL REVIEW THE TAPE AND DETERMINE AT THAT TIME IF THE SANITARY LATERAL NEEDS REPAIRING, OR REPLACING, OR IF IT IS STRUCTURALLY SOUND AND CAN BE USED IN ITS PRESENT CONDITION.

6) UNUSED LATERALS: ANY UNUSED WATER OR SANITARY SEWER LATERALS MUST BE ABANDONED AT THE CITY MAIN.

7) PROTECTION OF PROPERTY: IT IS THE RESPONSIBILITY OF THE CONTRACTOR TO PROTECT ALL THE STREET SIGNS, STREET LAMPS/LIGHTS, PARKING METERS, AND/OR TREES AROUND THE PROPERTY. IF THEY ARE DAMAGED, LOST, OR REMOVED IT IS THE RESPONSIBILITY OF THE CONTRACTOR TO REPLACE THEM AT THE CONTRACTOR'S EXPENSE. THE CONTRACTOR IS ALSO RESPONSIBLE FOR ANY STREET MARKINGS THAT ARE DAMAGED OR REMOVED BY THE CONTRACTOR'S OPERATIONS. CONTACT THE PUBLIC WORKS INSPECTOR FOR SIGN SPECIFICATION AND SUPPLIERS.

8) WATER METERS: WATER METERS MUST REMAIN ACCESSIBLE FOR METER READERS DURING CONSTRUCTION WATER METERS SHALL BE PLACED NEAR THE PROPERTY LINE AND OUT OF THE DRIVEWAY APPROACH WHENEVER POSSIBLE. THE WATER METER BOX MUST BE PURCHASED FROM THE CITY AND MUST HAVE A TRAFFIC-RATED LID IF THE BOX IS LOCATED IN THE DRIVEWAY

9) PARKWAY TREES: IF ANY PARKWAY TREES ARE REMOVED. THEY MUST BE REPLACED WITH TREES SELECTED FROM THE CITY'S APPROVED PARKWAY TREE LIST AND PLANTED IN ROOT BARRIER BOXES.

10) BEST MANAGEMENT PRACTICES: EROSION AND SEDIMENT CONTROL DEVICES BMPS (BEST MANAGEMENT PRACTICES) MUST BE IMPLEMENTED AROUND THE CONSTRUCTION SITE TO PREVENT DISCHARGE TO THE STREET AND ADJACENT PROPERTIES. CONTROL MEASURES MUST ALSO BE TAKEN TO PREVENT STREET SURFACE WATER FROM ENTERING THE SITE.

11) DRAIN LINES: ALL DRAIN LINES INSTALLED WITHIN THE STREET RIGHT-OF-WAY MUST BE CONSTRUCTED OF DUCTILE IRON PIPE. DRAINS MUST BE SHOWN ON PLANS.

12) RUNOFF DISCHARGE: ALL RUNOFF WATER FROM THE ROOF AND SIDE YARDS AND PATIOS MUST DISCHARGE ONTO STREET.

13) UNDERGROUND UTILITIES: A) ALL NEW OR EXISTING BUILDINGS AND STRUCTURES IN THE CITY OF MANHATTAN BEACH SHALL PROVIDE UNDERGROUND ELECTRICAL AND COMMUNICATION SERVICE LATERALS ON THE PREMISES TO BE SERVED, AS REQUIRED IN MBMC 9.12.050.

B) ALL ELECTRICAL, TELEPHONE, CABLE TELEVISION SYSTEMS, AND SIMILAR SERVICE WIRES AND CABLES THAT PROVIDE DIRECT SERVICE TO NEW MAIN BUILDINGS, NEW ACCESSORY BUILDINGS, AND STRUCTURES, SHALL BE INSTALLED UNDERGROUND IN COMPLIANCE WITH ALL APPLICABLE BUILDING AND ELECTRICAL CODES, SAFETY REGULATIONS AND ORDERS RULES OF THE PUBLIC. UTILITIES COMMISSION OF THE STATE OF CALIFORNIA, AND

SPECIFICATIONS OR STANDARDS OF THE PUBLIX WORKS DEPARTMENT. C) ALL ELECTRICAL, TELEPHONE, CABLE TELEVISION SYSTEMS, AND SIMILAR SERVICE WIRES AND CABLES SHALL

ALSO BE PLACED UNDERGROUND WHEN EXISTING BUILDINGS, EXISTING ACCESSORY BUILDINGS, AND STRUCTURES ARE REPAIRED. REMODELED. ALTERED OF EXPANDED, WHERE THE VALUE, AS DETERMINED FOR BUILDING PERMIT FEE PURPOSES, BY THE BUILDING CODE

OF THE CITY OF MANHATTAN BEACH, OF SUCH REPAIRS OR REMODELLING, OR EXPANSION EXCEEDS FIFTY PERCENT (50%) OF THE VALUE OF THE BUILDING OR STRUCTURE AS DETERMINED BY THE CALIFORNIA BUILDING CODE.

D) WRITING BETWEEN THE ACCESSORY BUILDINGS AND THE MAIN BUILDINGS SHALL BE IN AN UNDERGROUND SYSTEM.

E) FUTURE UNDERGROUND UTILITY SERVICES EQUIPMENT SHALL BE INSTALLED AT THE TIME OF CONSTRUCTION FOR NEW OR EXISTING BUILDINGS AND STRUCTURES. FUTURE UNDERGROUND UTILITY EQUIPMENT SHALL INCLUDE ALL CONDUITS, WIRES, PULLBOXES, ELECTRICAL PANELS, AND OTHER APPURTENANCES THAT MAY BE REQUIRED FOR FUTURE UNDERGROUND UTILITY SERVICES FROM THE BUILDING OR STRUCTURE TO AN APPROVED LOCATION ON THE PROPERTY LINE OF THE PARCEL. WHERE A BUILDING OR STRUCTURE IS SERVED BY UTILITIES NOT SITUATED ON THE SAME SIDE OF THE PUBLIC STREET. OR. NOT LOCATED IN THE PUBLIC RIGHT-OF-WAY AT THE FRONT OF THE PROPERTY, THE PROPERTY MAY CONTINUE TO BE SERVED FROM THE ALTERNATE LOCATION AND BY OVERHEAD WIRES UNTIL COMPLETION SAID FUTURE UNDERGROUND UTILITY CONVERSION

F) THE CONTRACTOR AND OWNER ARE JOINTLY AND SEVERALLLY RESPONSIBLE FOR COMPLYING WITH THE REQUIREMENTS OF MBMC 9.12.050 AND SHALL MAKE THE NECESSARY ARRANGEMENTS WITH THE UTILITY COMPANIES SERVICING THE STRUCTURE FOR THE INSTALLATION OF SUCH FACILITIES.

#### **BUILDING AND SAFETY CONT.**

23) LAUNDRY VENTILATION: LAUNDRY VENTILATION EXHAUST SHALL TERMINATE AT LEAST 3 FEET FROM THE PROPERTY LINE AND 3 FEET FROM OPENINGS INTO ANY BUILDINGS. [CMC 504.5]

24) CLOTHES DRYER DUCT: A DOMESTIC CLOTHES DRYER DUCT SHALL BE OF METAL AND A MINIMUM OF 4 INCHES IN DIAMETER, THE EXHAUST DUCT SHALL NOT EXCEED A TOTA COMBINED HORIZONTAL AND VERTICAL LENGTH OF 14 FEET INCLUDING TWO 90 DEGREES ELBOWS. TWO FEET SHALL BE DEDUCTED FOR EACH 90-DEGREE ELBOW IN EXCESS OF TWO. [CMC 504.4.2.1]

#### **BUILDING AND SAFETY**

1) CONSTRUCTION TIMES: CONTRACTOR SHALL CONFIRM HOURS FOR CONSTRUCTION ACTIVITY WITH LOCAL AGENCY AND ONLY OPERATE DURING APPROVED HOURS. NO CONSTRUCTION IS PERMITTED OUTSIDE OF THOSE HOURS.

2) CONSTRUCTION SIGNS: THE CONTRACTOR SHALL CONFIRM REQUIREMENTS FOR CONSTRUCTION SITE SIGNAGE WITH LOCAL AGENCY, THE CONTRACTOR SHALL PROVIDE AND MAINTAIN THE REQUIRED SIGNAGE AT THE PROJECT SITE AT ALL TIMES.

3) CONSTRUCTION FENCE: THE CONTRACTOR SHALL PROVIDE A CONSTRUCTION FENCE PER CBC 3303 AT THE PUBLIC RIGHT-OF-WAY FOR PEDESTRIAN PROTECTION IF ANY WORK IS TO BE PERFORMED ON ANY BUILDING OR STRUCTURE ADJACENT TO THE PUBLIC RIGHT-OF-WAY.

4) DEMOLITION: NO DEMOLITION SHALL COMMENCE WITHOUT A VALID DEMOLITION PERMIT. WORK COMMENCES WITHOUT A VALID PERMIT MAY BE SUBJECT TO A SPECIAL INVESTIGATION BEFORE A PERMIT MAY BE ISSUED.

5) GRADING PERMIT: A GRADING PERMIT IS REQUIRED WHEN GRADING OR EXCAVATION INVOLVES A CUT OR FILL DEPTH OF 3' OR MORE AND/OR 200 CUBIC YARDS. SUBMIT THE GRADING PLAN AND SOIL REPORT TO THE BUILDING DIVISION FOR REVIEW AND APPROVAL. DUST SHALL BE CONTROLLED CONTINUOUSLY BY WATERING OR BY OTHER APPROVED MEANS OF EXCAVATING. CONTRACTOR SHALL NOTIFY THE UNDERGROUND SERVICE ALERT (1-800-422-4133) PRIOR TO ANY EXCAVATION.

6) SHORING PERMIT: A SHORING PERMIT IS REQUIRED FOR ANY VERTICAL CUT OR FILL THAT IS EQUAL TO OR GREATER THAN 5' IN HEIGHT ENGINEERED SHORING PLAN CALCULATIONS AND SOIL REPORTS MUST BE SUBMITTED TO THE BUILDING DIVISION FOR REVIEW AND APPROVAL PER SECTION 3301.2 OF THE CBC. THE HOLDER OF A SHORING PERMIT SHALL NOTIFY IN WRITING ALL THE OWNERS OF ADJOINING PROPERTIES NOT LESS THAN 10 DAYS BEFORE SUCH EXCAVATION IS TO COMMENCE. AN OSHA PERMIT IS ALSO REQUIRED - A COPY OF WHICH SHALL BE SUBMITTED TO THE BUILDING DEVISION. SHORING CONTRACTOR SHALL NOTIFY THE UNDERGROUND SERVICE ALERT (1-800-422-4133) PRIOR TO ANY EXCAVATION.

7) SANDBLASTING: THE SANDBLASTING MUST BE WET SANDBLASTING AND ALL THE PRECAUTIONARY MEASURES MUST BE TAKEN BY THE CONTRACTOR TO PROTECT THE LIFE AND PROPERTY OF NEIGHBORS, RESIDENTS, AND THE PUBLIC. ADJACENT PROPERTY OWNERS MUST BE NOTIFIED AT LEAST (2) DAYS PRIOR TO SANDBLASTING.

8) SITE DRAINAGE: PROVIDE ROOF GUTTERS AND DOWNSPOUTS OR CONCRETE PAVEMENT/SWALE ON THE GROUND TO DIVERT OR CARRY SURFACE WATER AWAY FROM THE BUILDING TO CATCH BASIN AND DRAIN PIPES THROUGH CURB TO THE STREET AND STORM DRAIN SYSTEM.

9) STAIRWAYS: THE WIDTH OF STAIRWAYS SHALL BE 36" MIN CLEAR TAKEN FROM THE FACE OF THE FINISH. GUARDRAILS OR HANDRAIL PICKETS SHALL HAVE A MAXIMUM 4" SPACING BETWEEN PICKETS.

10) GARAGE DOOR: GARAGE DOOR OPENING INCLUDING HARDWARE SHALL BE 7' MINIMUM AND 18' WIDE. GARAGE DOOR SPRINGS AND OPENERS SHALL BE STATE-APPROVED AND WITH MANUFACTURER'S LABEL. THE DOOR LEADING FROM THE GARAGE TO THE DWELLING UNIT SHALL BE A 20 MINUTE FIRE RATED, 1-3/8" SOLID WOOD, SELF-CLOSING, AND TIGHT FITTING DOOR

11) NAILS: ONLY COMMON NAILS SHALL BE PERMITTED FOR THE REQUIRED NAILINGS ON VERTICAL AND HORIZONTAL DIAPHRAGMS SUCH AS SHEAR WALLS AND ROOF/FLOOR SHEATHINGS RESPECTIVELY.

12) REBAR WELDING: WELDING OF REBAR SHALL COMPLY WITH CBC\_STANDARD 19-1 THE CONTRACTOR IS TO SUBMIT WELDING PROCEDURES AND QUALIFICATION OF DEPUTY/ SPECIAL INSPECTIONS IN ACCORDANCE WITH THE SPECIAL INSPECTION PROGRAM TO THE BUILDING DIVISION FOR APPROVAL PRIOR TO ANY WELDING WORK.

13) FUTURE UTILITIES: CONTRACTOR TO PROVIDE UNDERGROUND CONDUIT FOR FUTURE ELECTRICAL LINES AT THE FRONT PROPERTY LINES. CONTRACTOR TO COORDINATE WITH THE INSPECTOR FOR ADDITIONAL COMMENTS.

14) EXTERIOR WALL ASSEMBLIES: 1 - TWO LAYERS OF GRADE D OR 60-MINUTE GRADE D PAPER APPLIED OVER WOOD BASE SHEATHING (CRC R703 7 3 & R703 2) 2 -A MINIMUM OF 0.019 INCH (No. 26 GALVANIZED SHEET PAGE) CORROSION-RESISTANT WEEP SCREED. (CRC

R703.1.1 & R703.7.2.1). 3 - THE SCREED SHALL BE INSTALLED WITH THE WEEP OPENINGS LOCATED A MINIMUM 1 INCH BELOW THE FOUNDATION PLATE LINE AND 4 INCHES ABOVE THE FINISH GRADE OR 2 INCHES ABOVE PAVED AREAS. (CRC R703.1.1 & R703 7 2 1)

4- BEHIND SIDING PROVIDE MINIMUM OF ONE LAYER OF No. 15 ASPHALT FELT. FREE FROM HOLES AND BREAK COMPLYING WITH ASTM D 226 FOR TYPE 1 FELT SHALL BE APPLIED OVER WALLS. (CRC R703.2).

15) BUILDING PAPER & WEEP: BUILDING PAPER & WEEP SCREED SHALL BE PROVIDED AND DETAILED BEHIND ADHERED AND/OR ANCHORED STONE OR MASONRY VENEER. SIMILAR TO STUCCO WALL ASSEMBLIES. (CRC R703.8)

16) SLEEPERS OR SILLS: SLEEPERS OR SILL ON A CONCRETE OR MASONRY SLAB IN DIRECT CONTACT WITH FARTH UNLESS SEPARATED FROM SUCH SLAB BY AN IMPERVIOUS MOISTURE BARRIER SHALL BE OF NATURALLY DURABLE OR PRESERVATIVE-TREATED WOOD. (R317.1 CRC)

17) VENEER: VENEER IS LIMITED TO LESS THAN 2 INCHES THICK AND LESS THAN 25 PSF INSTALLED SYSTEM WEIGHT. (CRC R703.3(1))

18) OUTDOOR LIGHTING: PER 150.0 (k)3A OUTDOOR LIGHTING MUST EITHER HAVE PHOTOCELL AND MOTION SENSOR, OR PHOTO CONTROL AND AUTOMATIC TIME SWITCH CONTROL, ASTRONOMICAL TIME CLOCK, OR ENERGY MANAGEMENT CONTROL SYSTEM. SHOW ALL EXTERIOR LIGHTING ON THE PLANS.

19) WATER HEATER: REGARDLESS OF PROPOSED WATER HEATING SYSTEM, SHALL HAVE: (BEES 150.0 (N)1A0D) a. A 120V electrical receptacle that is within 3 feet from the water

b. A Category III or IV vent, or a Type B vent with straight pipe. c. Condensate drain that is no more than 2 inches higher than the

finish surface below. d. A gas supply line with available capacity for not less than a

200,000 BTU/hr system. 3. All Plumbing fixtures and fittings shall comply with the following maximum flowrates:

(CGBSC 4,303.1) a. Water Closets 1.28 gallons/flush

b. Showerheads – single 1.8 gpm @ 80 psi c. Showerheads – multiple 1.8 gpm @ 80 psi combined

d. Lavatory faucets 1.2 gpm @ 60 psi

e. Kitchen faucets 1.5 gpm @ 60 psi

20) EXHAUST VENTILATION: PROVIDE LOCAL EXHAUST VENTILATION FOR EACH KITCHEN OR SIMILAR COOKING

area with: (CMC 504.2 and ASHRAE 62.2) (BEES 150.0(o) a. Minimum exhaust rate of 100 cfm; b. Maximum sound rating of 3 sones @100 cfm; and, c. Venting directly to the building exterior

21) SHOWERS & TUB-SHOWER: SHOWER AND TUB-SHOWER CÓMBINATION VALVES SHALL BE EQUIPPED WITH A MEANS TO LIMIT THE MAXIMUM SETTING OF THE VALVE TO 120 DEGREES F. [CPC 408.3]

22) CLOTHES DRYER: WHEN A DOMESTIC CLOTHES DRYER IS LOCATED IN A CLOSET, A MINIMUM OPENING OF 100 SQUARE INCHES FOR MAKEUP AIR SHALL BE PROVIDED IN THE DOOR. [CMC 504.4.1]

#### **PLANNING NOTES**

1) **SEPARATE PERMITS**: SEPARATE PERMITS AND PLANS ARE REQUIRED FOR SPAS, POOLS, SOLAR PANELS, DEMOLITION, AND SEWER CAP OF EXISTING BUILDINGS.

2) VERTICAL PROJECTIONS IN SETBACKS: FENCE, WALL, AND HANDRAIL HEIGHTS AS MEASURED FROM THE LOWEST FINISHED GRADE ADJACENT TO EACH SECTION OF THESE STRUCTURES, MAY BE A MAXIMUM OF 42" IN THE FRONT YARD SETBACK, AND 72" AT ALL OTHER LOCATIONS ON SITE UNLESS LOCATED IN A LINE-OF-SIGHT OR DRIVEWAY VISIBILITY AREA. CONTRACTOR TO CONFIRM HEIGHT LIMITATIONS WITH THE LOCAL PLANNING DEPARTMENT

3) ADDRESS NUMBERS: BUILDING ADDRESS NUMBERS SHALL CONTRACT WITH THEIR BACKGROUND AND BE 4" MINIMUM HIGH WITH A MINIMUM STROKE WIDTH OF 0.5" PER CBC R319.9.

4) ON-SITE PARKING: PARKING IS NOT PERMITTED IN REQUIRED YARDS OR OPEN SPACE EXCEPT FOR A 20' WIDE FRONT YARD DRIVEWAY.

5) FUTURE SOLAR WATER HEATING: A "CAPPED TEE" FITTING MUST BE INSTALLED OVER THE COLD WATER SUPPLY LINE ABOVE THE WATER HEATER FOR FUTURE SOLAR WATER HEATING. PIT RELIEF VALVE SHALL TERMINATE OUTSIDE THE BUILDING

6) UNDERGROUND CONDUIT: ROUTE UNDERGROUND CONDUIT TO POWER POLE PER PUBLIC WORKS STANDARD DETAILS. STUB OUT FOR PROPERTY LINE FOR FUTURE UNDER-GROUNDING OF UTILITIES WHEN APPLICABLE.

7) MECHANICAL EQUIPMENT SCREENING: PROVIDE VISUAL SCREENING FOR PROPOSED MECHANICAL EQUIPMENT AND UTILITY METERS. TOP NEED NOT BE SCREENED IF LOCATED ON THE INTERIOR SIDE OF THE DWELLING.

8) METER CLEARANCE: GAS AND ELECTRIC METERS MUST CLEAR PROPERTY LINES BY 3'-0" AND 6'-0" HEIGHT X 2'- 6" WIDTH. (COORDINATE WITH UTILITY COMPANY)

9) CESSPOOL LOCATIONS: IF THERE IS AN EXISTING CESSPOOL ON SITE. IT MUST BE LOCATED BY CITY PERSONNEL BEFORE DEMOLITION OR BUILDING PERMITS CAN BE ISSUED. THE CONTRACTOR IS TO VERIFY THE EXISTENCE OF THE CESSPOOL WITH THE LOCAL AUTHORITY HAVING JURISDICTION PRIOR TO PROCEEDING WITH DEMOLITION OR CONSTRUCTION ACTIVITIES.

### MANHATTAN BEACH CITY NOTES

1) REFUSE STORAGE: RESIDENTIAL PROPERTIES MUST PROVIDE AN ENCLOSED STORAGE AREA FOR REFUSE CONTAINERS. THESE AREAS MUST BE CONSTRUCTED TO MEET THE REQUIREMENTS OF MBMC 5.24.030. THE AREA MUST BE SHOWN IN DETAIL ON THE PLANS BEFORE A PERMIT IS ISSUED.

2) DRIVEWAY HEIGHT: THE BACK OF THE DRIVEWAY APPROACH MUST BE 6" HIGHER THAN THE FLOW LINE ON THE STREET PER MBMC 9.76.030.

3) PUBLIC WAY IMPROVEMENTS: SIDEWALK, DRIVEWAY, CURB, AND GUTTER REPAIRS OR REPLACEMENT MUST BE COMPLETED PER PUBLIC WORKS SPECIFICATIONS. IN THE CASE WHERE THE GARAGE LEVEL IS BELOW THE STREET DRAINAGE FLOW LINES THE COMBINED SLOPE OF THE PUBLIC AND PRIVATE APPROACH SHALL NOT EXCEED 15%. IT SHALL BE THE DUTY OF EVERY PERSON CUTTING OR MAKING AN EXCAVATION ACROSS ANY PUBLIC STREET. ALLEY. OR SIDEWALK, TO MAINTAIN ADEQUATE CROSSINGS FOR VEHICLES AND FOR PEDESTRIANS. (MBMC 17.16.100)

4) PROPERTY ADDRESS: THE PROPERTY ADDRESS(S) MUST BE PERMANENTLY AFFIXED TO THE BUILDING IN ACCORDANCE WITH MCBF 505.1 PRIOR TO THE FINAL FIRE INSPECTION. [MBMC 3.16.29].

5) EXHAUST FAN: NO EXHAUST FANS OR VENTS SHALL SERVE MORE THAN ONE (1) DWELLING UNIT

6) WATER PIPES: ALL WATER PIPES TO SINKS AND LAUNDRY FACILITIES SHALL BE INSTALLED WITH SOUND-DEADENING MATERIALS TO PREVENT THE TRANSFER OF NOISE.

7) PIPE NOISE: ALL VOIDS AROUND PIPES SHALL BE PACKED WITH ROCK WOOL OR EQ. SOUND-DEADENING MATERIALS TO PREVENT THE TRANSFER OF NOISE.

8) PLUMBING LOCATION: NO PLUMBING VENTS OR SIMILAR EQUIPMENT SHALL BE PLACED BACK TO BACK BETWEEN SEPARATE DWELLING UNITS.

#### **BEST MANAGEMENT PRACTICES**

1) TYPE OF CONSTRUCTION: ALL PERSONS WORKING ON THE SITE SHOULD OBTAIN, READ, AND UNDERSTAND THE BEST MANAGEMENT PRACTICES PAMPHLET FOR THE TYPE(S) OF CONSTRUCTION BEING DONE.

2) SITE WASH-OFF: STOCKPILES OF SOILS, DEMOLITION DEBRIS, CEMENT, SAND, TOPSOIL, ETC., MUST BE COVERED WITH WATERPROOF MATERIALS OR BERMED TO PREVENT BEING WASHED OFF-SITE.

3) LIQUID MATERIALS: FUELS, OILS, PAINTS, SOLVENTS, AND OTHER LIQUID MATERIALS MUST NOT BE WASHED INTO THE STREET.

4) CONCRETE WASTE: WASTE CONCRETE MUST NOT BE WASHED INTO STREETS, STORM DRAIN CATCH BASINS, OR PUBLIC RIGHT-OF-WAY, ALL DUST AND SLURRY FROM CONCRETE CUTTING MUST BE REMOVED USING WET-DRY VACUUM OR EQUIVALENT.

5) SOLID WASTE: TRASH AND OTHER CONSTRUCTION SOLID WASTE MUST BE PLACED IN A COVERED TRASH RECEPTACLE.

6) ERODED SOIL: ERODED SOIL FROM DISTURBED SLOPED MUST BE CONTAINED USING BERMS, SILT FENCES, SETTING BASINS, OR GOOD EROSION MANAGEMENT PRACTICES SUCH AS RESEEDING.

7) WASH WATER WASH WATER FROM CLEANING CONSTRUCTION VEHICLES AND EQUIPMENT MUST BE KEPT ON-SITE WITHIN A CONTAINMENT AREA.

8) CONCRETE DRIVEWAY: CONSTRUCT NEW COMMERCIAL CONCRETE DRIVEWAY TYPE WHERE NOTED ON THE SITE PLAN. NEW CONCRETE SHALL BE CLASS 520-C-2500.

9) PREFABRICATED BEAMS: SUBMIT A CERTIFICATE OF PREFABRICATED BEAMS TO BUILDING INSPECTOR PRIOR TO INSTALLATION OF SUCH BEAM.

#### EGRESS NOTES

1) BASEMENT AND BEDROOMS SHALL HAVE A LEAST ONE EXTERIOR EMERGENCY ESCAPE AND RESCUE OPENING MEETING ALL OF THE FOLLOWING:

1. A MINIMUM NET CLEAR OPENING OF 5.7 SQUARE FEET 2. A MINIMUM NET CLEAR OPENING HEIGHT OF 24 INCHES. 3. A MINIMUM NET CLEAR OPENING WIDTH OF 20 INCHES. 4. THE BOTTOM OF THE CLEAR OPENING NOT GREATER THAN 44" INCHES MEASURED FROM THE FLOOR PER SECTION R310.1 AND R310.2.

2) EMERGENCY ESCAPE AND RESCUE OPENING WITH A FINISHED SILL HEIGHT BELOW THE ADJACENT GROUND LEVEL SHALL BE PROVIDED WITH A WINDOW WELL MEETING THE FOLLOWING: HORIZONTAL SREA SHALL BE AT 9 SQUARE FEET. MINIMUM DIMENSION OF 36 INCHES AND WITH AN APPROVED PERMANENT LADDER WHEN THE WELL HAS A VERTICAL DEPTH OF MORE THAN 44 INCHES PER SECTION R310.2.3.

C) THE WINDOW WELL SHALL BE DESIGNED FOR PROPER DRAINAGE BY CONNECTING TO THE BUILDING'S FOUNDATION DRAINAGE SYSTEM OR BY AN APPROVED ALTERNATE METHOD PER SECTION R310.2.3.2.

#### LIGHT AND VENTILATION

1) SINGLE FAMILY RESIDENCE AND ACCESSORY DWELLING UNITS SHALL EACH HAVE A WHOLE BUILDING VENTILATION SYSTEM USING THE CENTRAL HVAC SYSTEM OR DEDICATED EXHAUST FAN - PER SECTION 150.0(O). THE DEDICATED VENTILATION AIR DUCT SHALL CONNECT TO THE RETURN PLENUM OF THE AIR HANDLER AND THE DWELLING EXTERIOR. CERTIFICATE OF VERIFICATION (CF3R) SHALL BE COMPLETED, REGISTERED, AND SIGNED/CERTIFIED BY THE HERS RATER THE REGISTERED CE3R FORM SHALL BE MADE AVAILABLE TO THE BUILDING DEPARTMENT AND BUILDER.

B) PER CRC R303.1-1: A MECHANICAL VENTILATION SYSTEM CAPABLE OF PRODUCING .35 AIR CHANGES PER HOUR IN THE HABITABLE ROOMS SHALL BE INSTALLED IN ACCORDANCE WITH THE CALIFORNIA MECHANICAL CODE

#### **FIRE SPRINKLER NOTES**

1) AN AUTOMATIC RESIDENTIAL FIRE SPRINKLER SYSTEM SHALL BE INSTALLED IN THE DWELLING AND OTHER AREAS AS REQUIRED BY THE FIRE CODE OFFICIAL

2) AUTOMATIC RESIDENTIAL FIRE SPRINKLERS SHALL COMPLY WITH THE MANHATTAN BEACH FIRE DEPARTMENT MINIMUM REQUIREMENTS FOR NFPA 13D FIRE SPRINKLER SYSTEMS.

3) FIRE SPRINKLERS SHALL BE UNDER SEPARATE PLAN CHECK AND PERMIT [R313 CRC, 903.2.8.2 CFC AS AMENDED BY MBMC 3.16.0201

4) ANY EXISTING FIRE SPRINKLER OR FIRE ALARM SYSTEM MUST BE SUBMITTED FOR SEPARATE PLAN REVIEW.

5) THE FIRE SPRINKLER SHALL BE UNDER A SEPARATE PLAN CHECK PERMIT. ANY CHANGE TO EXISTING FIRE SPRINKLERS OR FIRE ALARM SYSTEMS MUST BE SUBMITTED FOR A SEPARATE PLAN REVIEW. [FIRE PREVENTION BUREA MANHATTAN BEACH FIRE DEPARTMENT]

6) HORN/STROBE ALARM DEVICES SHALL BE PLACED ON THE ADDRESS SIDE OF THE BUILDING UNLESS OTHERWISE SPECIFIED BY FIRE DEPARTMENT PERSONNEL.

#### PLUMBING NOTES

ALL PLUMBING FIXTURES AND FITTINGS SHALL COMPLY WITH THE FOLLOWING MAXIMUM FLOW RATES (CGBSC 4.303.1)

2. SHOWERHEADS-SINGLE 3. SHOWERHEADS-MULTI 4. LAVATORY FAUCETS 5. KITCHEN FAUCETS

1. WATER CLOSETS

1.28 GALLONS/FLUSH 1.8 GPM @ 80 PSI 1.8 GPM @ 80 PSI COMB. 1.2 GPM @ 60 PSI 1.5 GPM @ 60 PSI

#### **EROSION PROTECTION NOTES**

1) APPROVED EROSION PROTECTION DEVICES SHALL BE PROVIDED AND MAINTAINED FOR CONSTRUCTION DURING THE RAINY SEASON BETWEEN NOVEMBER 1ST AND APRIL 15TH AND SHALL BE PLACED AT THE END OF EACH DAY'S WORK

#### **ENERGY NOTES**

1) CERTIFICATE OF INSTALLATION (CF2R-ENV, CF2R-LTG, AND CFR2-MECH) SHALL BE COMPLETED BY THE APPLICABLE CONTRACTORS INSTALLING ENERGY FEATURES. WHEN COMPLIANCE REQUIRES HER FIELD VERFICATION OR TESTING, ALL CF2R FORMS SHALL BE SUBMITTED ELECTRONICALLY TO AN APPROVED HERS PROVIDER DATA REGISTR. THE CF2R FORMS SHALL BE POSTED AT THE JOB SITE IN A CONSPICUOUS LOCATION.

### GENERAL CONSTRUCTION CONT.

27) LATERAL MOVEMENT: ALL CONSTRUCTION SHALL BE STABILIZED AGAINST LATERAL MOVEMENT IN ACCORDANCE WITH REQUIREMENTS OF THE LATEST ADOPTED EDITION OF THE IBC IN THE LOCAL JURISDICTION AND IN STRICT ACCORDANCE WITH THE STRUCTURAL DETAILS OF THIS SET OF DRAWING.

28) WORK QUALITY: ALL WORK SHALL BE INSTALLED TRUE, PLUM, SQUARE, LEVEL, AND IN PROPER ALIGNMENT.

29) OFFSET STUDS: OFFSET STUDS WHERE REQUIRED SO THAT THE FINISH WALL SURFACES WILL BE FLUSH.

30) SEPARATE PERMITS: MECHANICAL, ELECTRICAL, PLUMBING, VERTICAL TRANSPORTATION, AND FIRE SPRINKLER WORK SHALL BE CONDUCTED UNDER A SEPARATE PERMIT AND SHALL NOT BE A PART OF THIS CONTRACT.

31) MANUFACTURER SPECIFICATIONS: THE CONTRACTOR AND/OR SUBCONTRACTOR IS TO INSTALL ALL FIXTURES, EQUIPMENT, AND MATERIALS PER MANUFACTURER'S SPECIFICATIONS.

32) GUARANTEE: THE CONTRACTOR SHALL GUARANTEE ALL WORK AGAINST FAULT OF ANY MATERIAL OR WORKMANSHIP FOR ONE YEAR AFTER COMPLETION AND ACCEPTANCE. FAULTY WORK SHALL BE REPLACED OR REPAIRED AS REQUIRED AT THE CONTRACTOR'S EXPENSE

### CODES

1) ALL WORK SHALL BE IN COMPLIANCE WITH ALL APPLICABLE CODES AS PRESCRIBED BY THE GOVERNING JURISDICTION WHERE THE PROJECT IS LOCATED. THE ENERGY CODE AND MECHANICAL CODE SHALL ALSO BE IN ACCORDANCE WITH THE CODES AS PRESCRIBED BY THE GOVERNING JURISDICTION. IN CASE OF CONFLICT WHERE METHODS OF STANDARDS OF INSTALLATION OR MATERIALS SPECIFIED DO NOT EQUAL OR EXCEED THE REQUIREMENTS OF THE LAWS OR ORDINANCES, THE ORDINANCES SHALL GOVERN. NOTIFY THE ARCHITECT OF ANY CONFLICT.

2) IT IS THE RESPONSIBILITY OF THE GENERAL CONTRACTOR AND EACH AND EVERY SUBTRADE/SUBCONTRACTOR TO ENSURE EVERY ASPECT OF THIS WORK IS IN COMPLIANCE WITH THE PREVAILING CODES. NOTIFY THE ARCHITECT OF ANY CONFLICT.

3) ALL CONSTRUCTION WORK INCLUDING THE MATERIALS OF CONSTRUCTION AND PROCEDURES FOR STORING, DISPOSING OF, AND INSTALLING MATERIALS SHALL CONFIRM TO THE LATEST ADOPTED CODES OF THE LOCAL AUTHORITY HAVING JURISDICTION

#### DRAWINGS

1) THESE DRAWINGS ARE THE EXCLUSIVE PROPERTY OF THE ARCHITECT. AUTHORIZED REPRODUCTION MUST BEAR THE NAME OF THE FIRM.

2) IN CASE OF DISCREPANCY OR AMBIGUITY, CONTACT THE ARCHITECT FOR CLARIFICATION PRIOR TO PROCEEDING WITH ANY WORK

3) DRAWINGS INDICATE THE INTENT OF GENERAL AND TYPICAL DETAILS OF CONSTRUCTION. WHERE CONDITIONS ARE NOT SPECIFICALLY INDICATED BUT ARE OF SIMILAR CHARACTER TO DETAILS SHOWN, SIMILAR DETAILS OF CONSTRUCTION SHALL BE USED ONLY SUBJECT TO REVIEW AND APPROVAL BY THE ARCHITECT.

4) THE CONTRACTOR SHALL FURNISH SHOP DRAWINGS FOR THE ARCHITECT'S APPROVAL PRIOR TO THE MANUFACTURE OF ANY CABINET WORK, MILLWORK, AND ANY OTHER SPECIAL ITEMS REQUIRING CUSTOM SHOP FABRICATED WORK.

5) DRAWINGS INCLUDE ABBREVIATIONS THAT ARE COMMON USE. THE LIST OF ABBREVIATIONS PROVIDED IS NOT INTENDED TO BE COMPLETE OR REPRESENTATIVE OF CONDITIONS OR MATERIALS SPECIFICALLY USED ON THE PROJECT. THE ARCHITECT WILL DEFINE THE INTENT OF ANY DEFINITION OR TERM IN QUESTION.

6) WORK INDICATED ON THE DRAWINGS OR IN THE SPECIFICATIONS AS NIC OR BY SEPARATE CONTRACTORS. IS NOT INCLUDED WITH THE CONTRACT OR CONSTRUCTION DOCUMENTS FOR THE PROJECT. THE CONTRACTOR SHALL COOPERATE FULLY WITH ALL SEPARATE CONTRACTORS CONTRACTED WITH THE OWNER.

### SUPPLEMENTARY DRAWINGS AND SPECIFICATIONS

1) STRUCTURAL. MECHANICAL, ELECTRICAL, PLUMBING, AND FIRE PROTECTION DRAWINGS ARE SUPPLEMENTARY OF THESE DRAWINGS. THE CONTRACTOR SHALL COORDINATE THE WORK OF EACH CONSULATING ENGINEER WITH THESE DRAWINGS OR SPECIFICATIONS AND SHALL NOTIFY THE ARCHITECT OF ALL DISCREPANCIES WITH A WRITTEN REQUEST FOR CLARIFICATION. ANY WORK INSTALLED IN CONFLICT WITH THESE CONTRACT DOCUMENTS SHALL BE CORRECTED SOLELY AT THE EXPENSE OF THE CONTRACTOR

2) THE CONTRACTOR SHALL SUBMIT TO THE ARCHITECT SUBMITTALS FOR REVIEW DURING CONSTRUCTION PRIOR TO THE COMMENCEMENT OF SPECIFIC WORK, SUBMITTALS INCLUDE BUT ARE NOT LIMITED TO, MATERIAL DATA SHEETS. PHYSICAL SAMPLES, AND SHOP DRAWINGS AND SHALL BE

SUPPLIED TO THE ARCHITECT AS REQUESTED. 3) NO SUBSITUTIONS ARE ALLOWED UNLESS PROPERLY SUBMITTED THROUGH A CHANGE ORDER AND APPROVED BY THE OWNER AND ARCHITECT.

4) ANY VALUE ENGINEERING OR SUBSTITUTE OF REQUIREMENTS, NOTED IN THE CONTRACT DOCUMENTS. TAKEN WITHOUT WRITTEN CONSENT FROM THE ARCHITECT SHALL RELEASE THE ARCHITECT FROM ANY AND ALL LIABILITY FOR THAT PORTION OF THE PROJECT.

#### DIMENSIONS

1) DO NOT SCALE THESE DRAWINGS, ALL INFORMATION SHOWN ON THE DRAWINGS RELATIVE TO EXISTING CONDITIONS IS GIVEN AS THE BEST PRESENT KNOWLEDGE BUT WITHOUT GUARANTEE OF ACCURACY. THE CONTRACTOR SHALL FIELD VERIFY EXISTING CONDITIONS AND DIMENSIONS AND SHALL NOTIFY THE ARCHITECT IMMEDIATELY IN WRITING OF ANY DISCREPANCIES OR CONDITIONS ADVERSELY AFFECTING THE DESIGN PRIOR TO PROCEEDING WITH THE ITEM OF WORK AFFECTED.

2) ALL DIMENSIONS ARE TO THE FACE OF STUD (F.O.S.) UNLESS NOTED OTHERWISE. CONTRACTOR SHALL NOTIFY ARCHITECT OF ANY DIMENSIONAL CONFLICTS WITHIN THE CONTRACT DOCUMENTS.

3) THE CONTRACTOR SHALL NOTIFY THE ARCHITECT OF ANY CONFLICTING DIMENSIONS BETWEEN ARCHITECTURAL + ENGINEERING DRAWINGS. THE DRAWINGS SHALL NOT BE SCALED.

### **GENERAL CONSTRUCTION**

1) CONSTRUCTION DOCUMENTS: THE CONTRACTOR SHALL BE RESPONSIBLE FOR READING AND COMPLYING WILL ALI NOTES INCLUDED IN THE CONTRACT DOCUMENTS. THE CONTRACTOR SHALL BRING ANY AND ALL DISCREPANCIES OR CONFLICTS TO THE ATTENTION OF THE ARCHITECT PRIOR TO CONSTRUCTION. THE CONTRACTOR SHALL THOROUGHLY REVIEW THE CONSTRUCTION DRAWINGS, SPECIFICATIONS ADDENDUMS, AND ANY REVISIONS ISSUED AND SHALL REPORT ANY ERRORS AND OMISSIONS TO THE ARCHITECT IMMEDIATELY IN WRITING. DO NOT VARY OR MODIFY THE WORK SHOWN EXCEPT UPON WRITTEN INSTRUCTIONS OF THE ARCHITECT. THE CONTRACTOR SHALL BE GOVERNED BY ALL CONDITIONS AS INDICATED IN THE CONSTRUCTION DRAWINGS, SPECIFICATIONS, AND ADDENDUMS.

2) MEANS AND METHODS; THE CONSTRUCTION DRAWINGS AND SPECIFICATIONS ARE REPRESENTATIONAL OF THE FINISHED STRUCTURE AND DO NOT INDICATE THE MEANS + METHODS OF CONSTRUCTION, TECHNIQUES, SEQUENCING, OR PROCEDURES REQUIRED FOR CONSTRUCTION.

3) SITE SAFETY: THE CONTRACTOR SHALL BE RESPONSIBLE FOR SAFETY IN THE AREA OF WORK IN ACCORDANCE WITH ALL APPLICABLE SAFETY CODES IN ORDER TO PROTECT ALL PERSONS INVOLVED WITH THE WORK OR VISIT THE SITE DURING THE CONSTRUCTION PERIOD.

ALL EXIT DOORS, EXIT ACCESS, AND COORIDORS SHALL REMAIN UNOBSTRUCTED AT ALL TIMES. MATERIALS SHALL NOT BE STORED OR STOCKPILED IN A MATTER THAT BLOCKS EGRESS OR CREATES AN UNSAFE CONDITION.

THE CONTRACTOR SHALL INDEMNIFY AND HOLD THE ARCHITECT HARMLESS FOR INJURY OR DEATH TO PERSONS OR FOR DAMAGE TO PROPERTY CAUSED BY NEGLIGENCE OF THE CONTRACTOR, THEIR AGENT, EMPLOYEES, OR SUBCONTRACTORS.

4) APPROVED DRAWING SET: THE CONTRACTOR SHALL KEEP AND MAINTAIN THE JURISDICTION-APPROVED RECORD SET OF DRAWINGS AT THE JOB SITE AT ALL TIMES. THE CONTRACTOR SHALL KEEP THE SET CURRENT WITH ANY APPROVED REVISIONS OR ADDENDA

5) MINIMUM STANDARDS OF WORK: IF ANY CONFLICT EXISTS IN QUALITY OF WORK OR CODE REQUIREMENTS, THE HIGHER QUALITY AND MORE RESTRICTIVE SHALL APPLY.

6) NOT IN SCOPE: WORK INDICATED ON THE DRAWINGS OR IN THE SPECIFICATIONS AS N.I.C. OR BY SEPARATE CONTRACTORS, IS NOT INCLUDED WITHIN THE CONTRACT OR CONSTRUCTION DOCUMENTS FOR THE PROJECT. CONTRACTOR SHALL COOPERATE FULLY WITH ALL SEPARATE CONTRACTORS CONTRACTED WITH THE OWNER.

7) CODE COMPLIANCE: THE WORK SHALL BE COMPLIANT WITH ALL APPLICABLE CODE, ORDINANCES, AND REGULATIONS LISTED IN THE CONSTRUCTION DOCUMENTS AND AS REQUIRED BY THE LOCAL AUTHORITY HAVING JURISDICTION.

8) OSHA COMPLIANCE: WORK SHALL COMPLY WITH PERTINENT HEALTH AND SAFETY REGULATIONS FOR REQUIRED METHODS TO PROTECT ALL PERSONS INVOLVED WITH THE WORK OR VISITING THE SITE DURING THE CONSTRUCTION PERIOD.

9) SITE MEASUREMENTS: THE CONTRACTOR SHALL BE RESPONSIBLE FOR VERIFYING ALL DIMENSIONS IN THE FIELD PRIOR TO STARTING ANY WORK. THE CONTRACTOR SHALL REPORT ANY DISCREPANCIES BETWEEN FIELD CONDITIONS AND THE DRAWINGS TO THE ARCHITECT PRIOR TO CONTINUING WORK

11) DETAILS: DETAILS PROVIDED WITHIN THE CONSTRUCTION DÓCUMENTS ARE INTENDED TO SHOW THE INTENT OF THE DESIGN. MINOR MODIFICATIONS MAY BE REQUIRED PER FIELD CONDITIONS. THE CONTRACTOR TO NOTIFY THE ARCHITECT OF SUCH REVISIONS.

12) SUBSTITUTIONS: NO SUBSTITUTIONS ARE ALLOWED UNLESS SPECIFICATIONS ARE SUBMITTED TO AND APPROVED BY THE OWNER AND ARCHITECT.

13) CONTRACT DEVIATIONS: ANY VALUE ENGINEERING OR SUBSTITUTION OF REQUIREMENTS NOTED IN THE CONTRACT DOCUMENTS TAKEN WITHOUT WRITTEN CONSENT FROM THE ARCHITECT, SHALL RELEASE THE ARCHITECT FROM ANY AND ALL LIABILITY FOR THAT PORTION OF THE PROJECT.

14) COORDINATION WITH CONTRACTORS/CONSULTANTS: THE CONTRACTOR SHALL COORDINATE THEIR WORK WILL ALL OTHER TRADES CONSULTANTS AND SUB-CONTRACTORS WORKING ON THE PROJECT WHETHER UNDER CONTRACT OF THE CONTRACTOR OR OWNER.

16) SITE ACCESS: THE CONTRACTOR SHALL GIVE THE CLIENT, ARCHITECT, CONSULTANTS, AND INSPECTORS ACCESS TO THE JOB SITE DURING NORMAL BUSINESS HOURS FOR THE DURATION OF CONSTRUCTION

17) SITE OBSERVATION: ANY SITE OBSERVATION BY THE ARCHITECT DURING CONSTRUCTION IS FOR THE SOLE PURPOSE OF REVIEWING THE WORK FOR COMPLIANCE WITH THE CONTRACT DOCUMENTS. THE ARCHITECT IS NOT RESPONSIBLE FOR THE INSPECTION OF PROTECTIVE MEASURES OR THE CONSTRUCTION PROCEDURES OR FOR GUARANTEEING THE CONTRACTOR'S WORK.

18) DAMAGES: EACH CONTRACTOR/SUBCONTRACTOR IS RÉSPONSIBLE FOR PROTECTING ALL WORK/AREAS ADJACENT TO THE CONSTRUCTION SITE AND IS LIABLE FOR ANY DAMAGE TO WORK/AREAS CAUSED BY THE MOVEMENT OF MATERIALS FOUIPMENT OR DUST ALL DAMAGE INCURRED SHALL BE REPAIRED AT THE CONTRACTOR'S EXPENSE

19) SITE EGRESS: ALL EXIT DOORS, EXIT ACCESS, AND CORRIDORS SHALL REMAIN UNOBSTRUCTED AT ALL TIMES. MATERIALS SHALL NOT BE STORED OR STOCKPILED IN A MANNER THAT BLOCKS EGRESS OR CREATES AN UNSAFE CONDITION.

20) SITE CLEANLINESS: THE CONTRACTOR SHALL MAINTAIN A CLEAN JOB SITE FREE OF TRASH AND DEBRIS. WORK AREAS SHALL BE MAINTAINED IN BROOM-CLEAN CONDITIONS AT THE END OF EACH WORK DAY/SHIFT

21) STORING + DISPOSING OF MATERIALS: ALL CONSTRUCTION WORK INCLUDING MATERIALS OF CONSTRUCTION AND PROCEDURES FOR STORING, DISPOSING OF, AND INSTALLING MATERIALS SHALL CONFORM TO THE LATEST ADOPTED CODES OF THE LOCAL AUTHORITY HAVING JURISDICTION.


22) ROUGH UTILITIES: CONTRACTOR SHALL FURNISH AND INSTALL ROUGH PLUMBING AND ELECTRICAL AND FINAL HOOK-UP FOR ALL SPECIFIED FIXTURES, APPLIANCES, AND EQUIPMENT.

23) ACCESS PANELS: CONTRACTOR SHALL INCLUDE IN THE BASE BID ALL ACCESS PANELS REQUIRED IN CEILINGS, WALLS, OR FLOORS FOR ACCESS TO ALL EQUIPMENT AS REQUIRED PER APPLICABLE CODE.

24) EQUIPMENT STANDARDS: ALL ELECTRICAL, MECHANICAL AND PLUMPING FIXTURES/EQUIPMENT SHOULD BE LISTED AND LABELED BY AN APPROVED TESTING AGENCY.


25) SUBMITTALS: THE CONTRACTOR SHALL SUBMIT TO THE ARCHITECT SUBMITTALS FOR REVIEW DURING CONSTRUCTION PRIOR TO THE COMMENCEMENT OF SPECIFIC WORK. SUBMITTALS INCLUDE MATERIAL DATA SHEETS, PHYSICAL SAMPLES, AND SHOP DRAWINGS AND SHALL BE SUPPLIED TO THE ARCHITECT AS REQUESTED.

**26) BLOCKING:** THE CONTRACTOR SHALL BE RESPONSIBLE FOR PROVIDING ALL BLOCKING, BUCKOUTS, BACKING, AND JACKS AS REQUIRED FOR THE INSTALLATION OF ALL WALL AND CEILING MOUNTED ITEMS. COORDINATE WITH THE ARCHITECT AND/OR OWNER FOR THE LOCATION OF ALL MOUNTED ITEMS WITH THE ARCHITECT

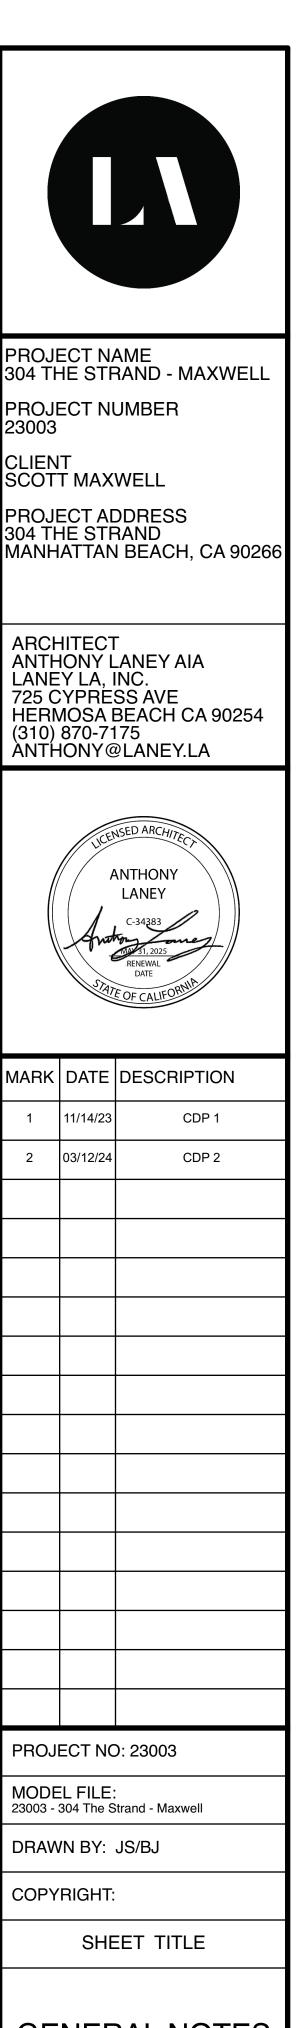






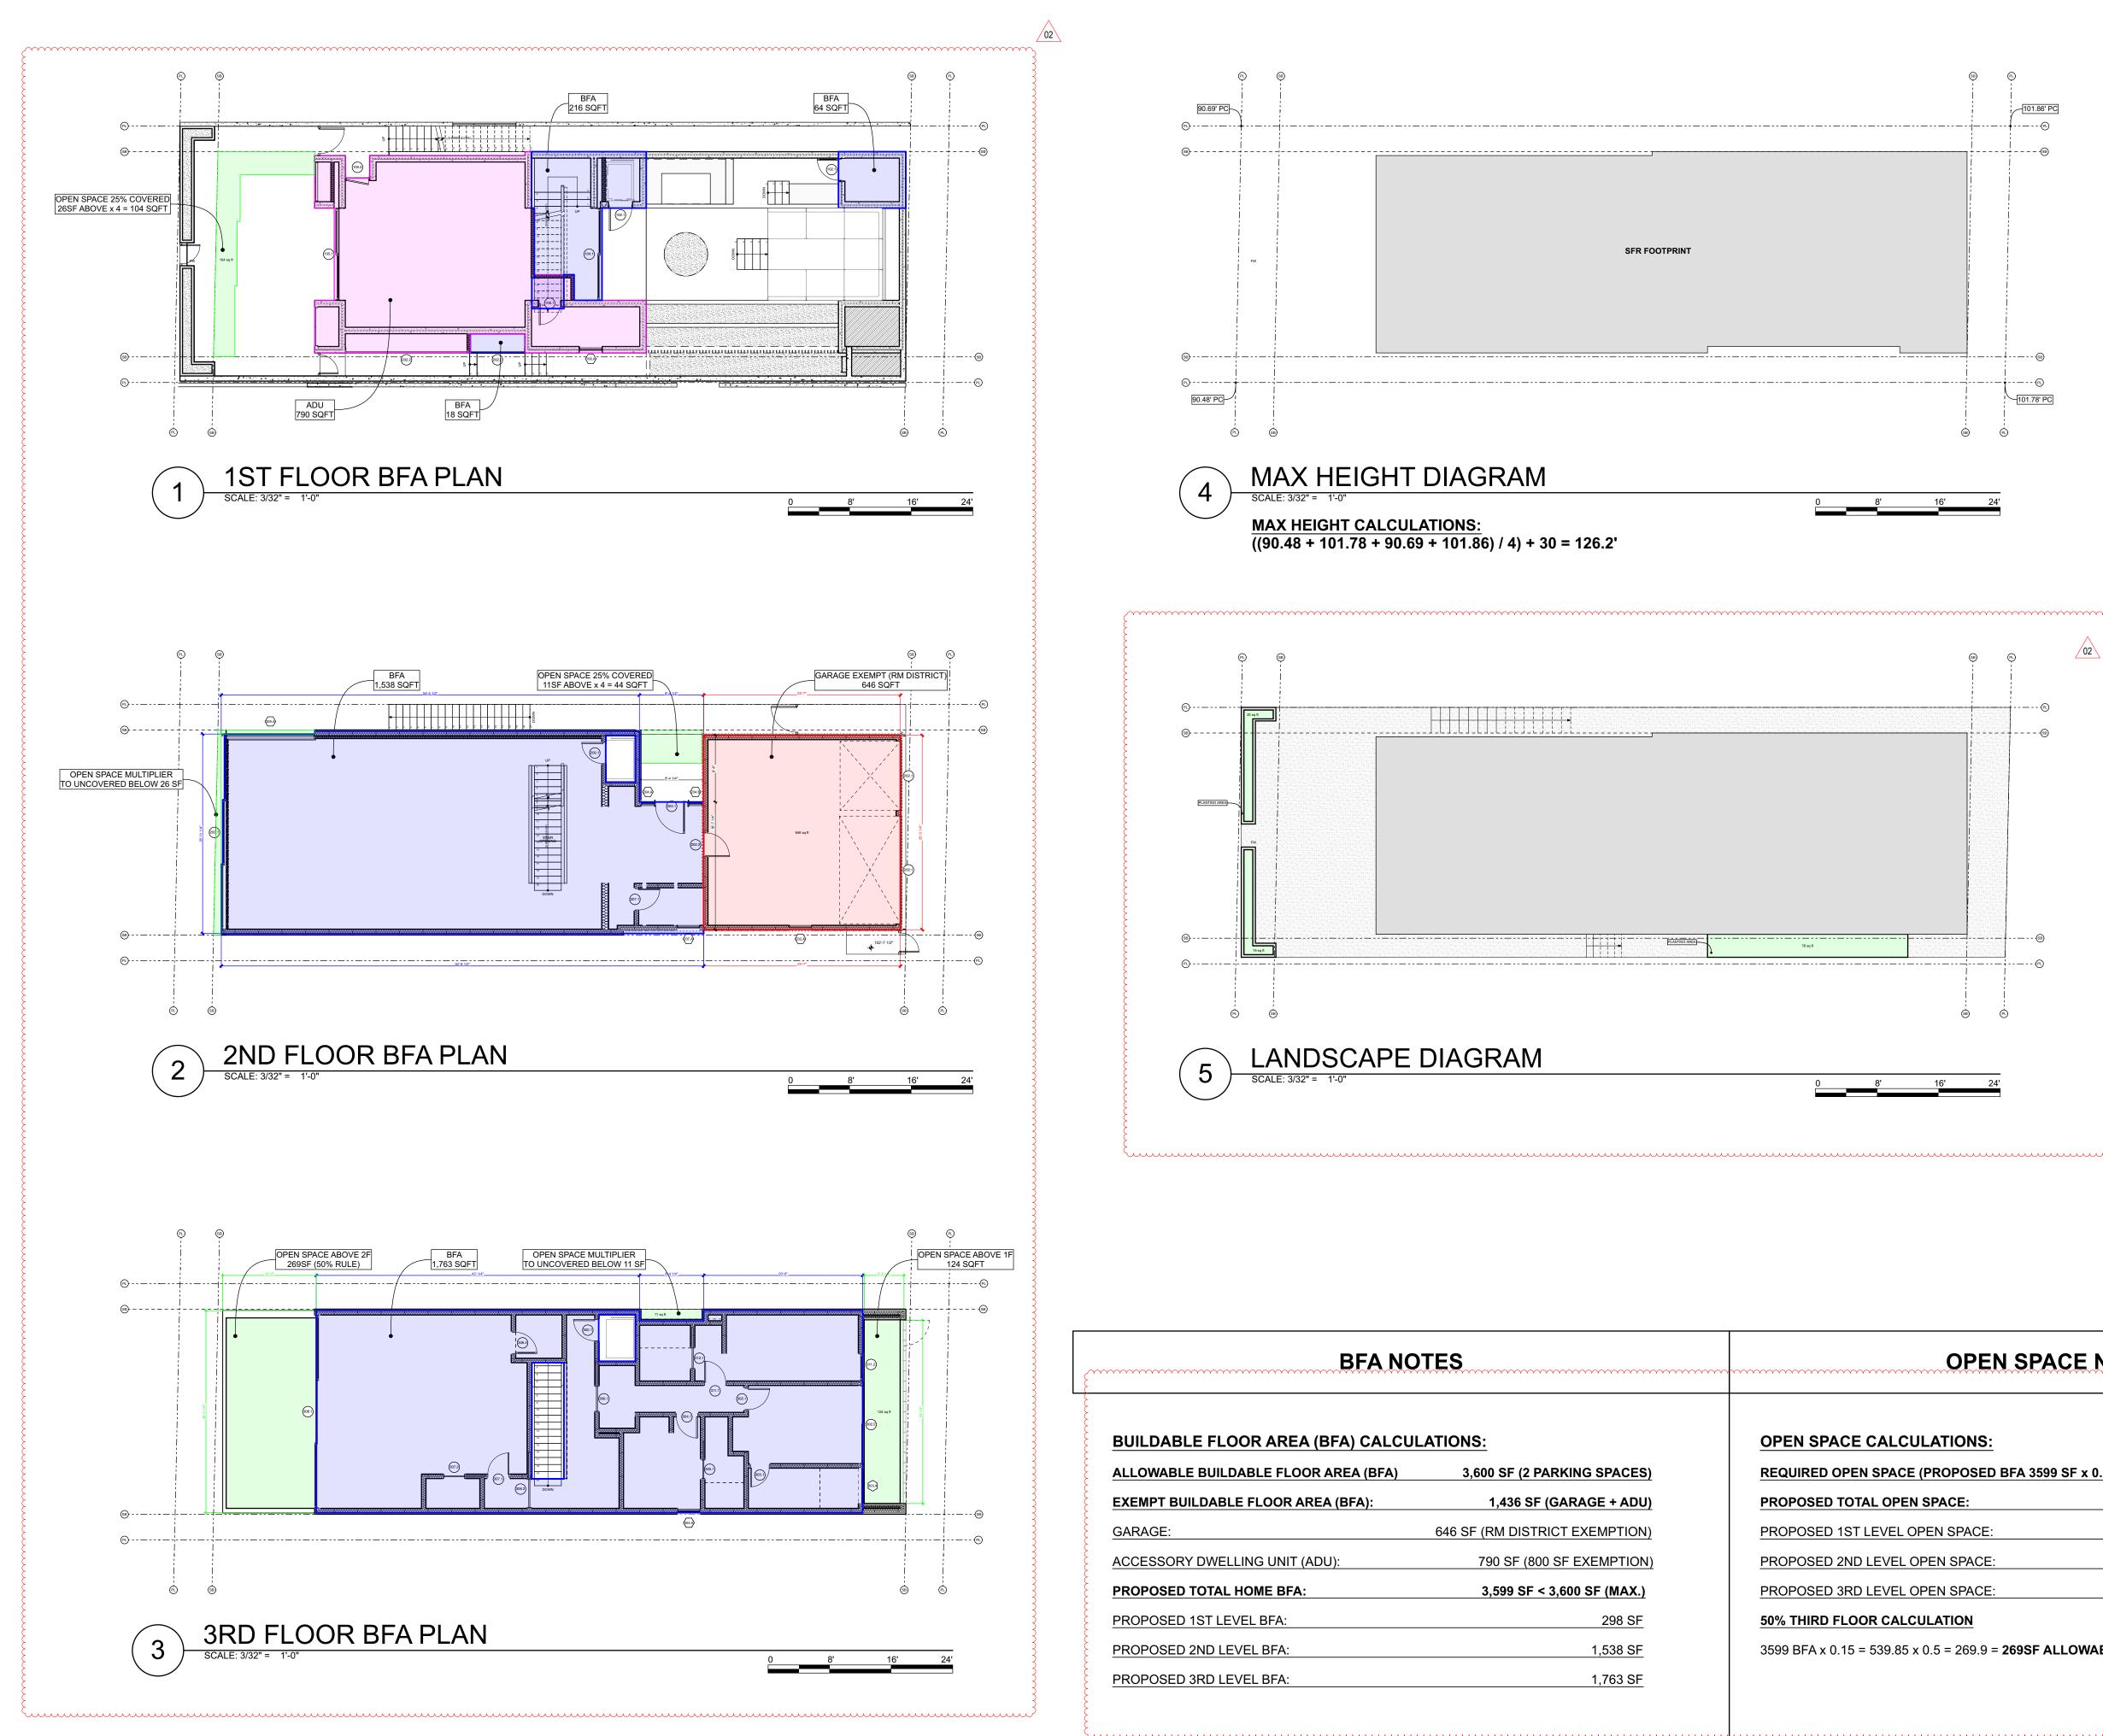

## **BFA DIAGRAMS**

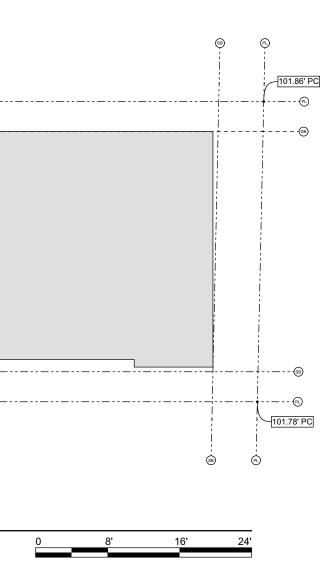

## **OPEN SPACE NOTES**

OPEN SPACE CALCULATIONS:	
REQUIRED OPEN SPACE (PROPOSED BFA 3599 SF x 0.15)	540 SF
PROPOSED TOTAL OPEN SPACE:	541 SF
PROPOSED 1ST LEVEL OPEN SPACE:	104 SF
PROPOSED 2ND LEVEL OPEN SPACE:	168 SF
PROPOSED 3RD LEVEL OPEN SPACE:	269 SF

3599 BFA x 0.15 = 539.85 x 0.5 = 269.9 = **269SF ALLOWABLE ABOVE 2F** 


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BENCHMARK NO. QY10274 / ELEVATION 27.232' (QUAD 2013 / NAVD88) LEAD AND DPW BM TAG IN E'LY CURB 4FT W'LY OF CATCH BASIN 1 6FT N'LY OF & 7 FT E'LY OF THE C/L THE STRAND & FIRST STREET SUBTRACT 63.45' FROM ALL ELEVATIONS SHOWN HEREON FOR NAVD88


A TITLE POLICY HAS BEEN PROVIDED AND REVIEWED BY DENN ENGINEERS AT THE TIME OF THIS SURVEY. NO EASEMENTS WERE IDENTIFIED ON THE PROVIDED TITLE REPORT PER THE FOLLOWING:

UPWARD TITLE COMPANY ORDER NO. 4220124-00250 DATED FEBRUARY 28, 2024



/ITHOUT WRITTEN CONSENT OF DENN ENGINEERS
HALL RELIEVE DENN ENGINEERS FROM ANY LIABILITY
R DAMAGE RESULTING FROM SUCH CHANGES OR
IODIFICATIONS, INCLUDING ANY ATTORNEYS FEES OR
OSTS INCURRED IN ANY PROCEEDING THAT DENN
NGINEERS MAY BE JOINED.
SHEET 1 OF 1

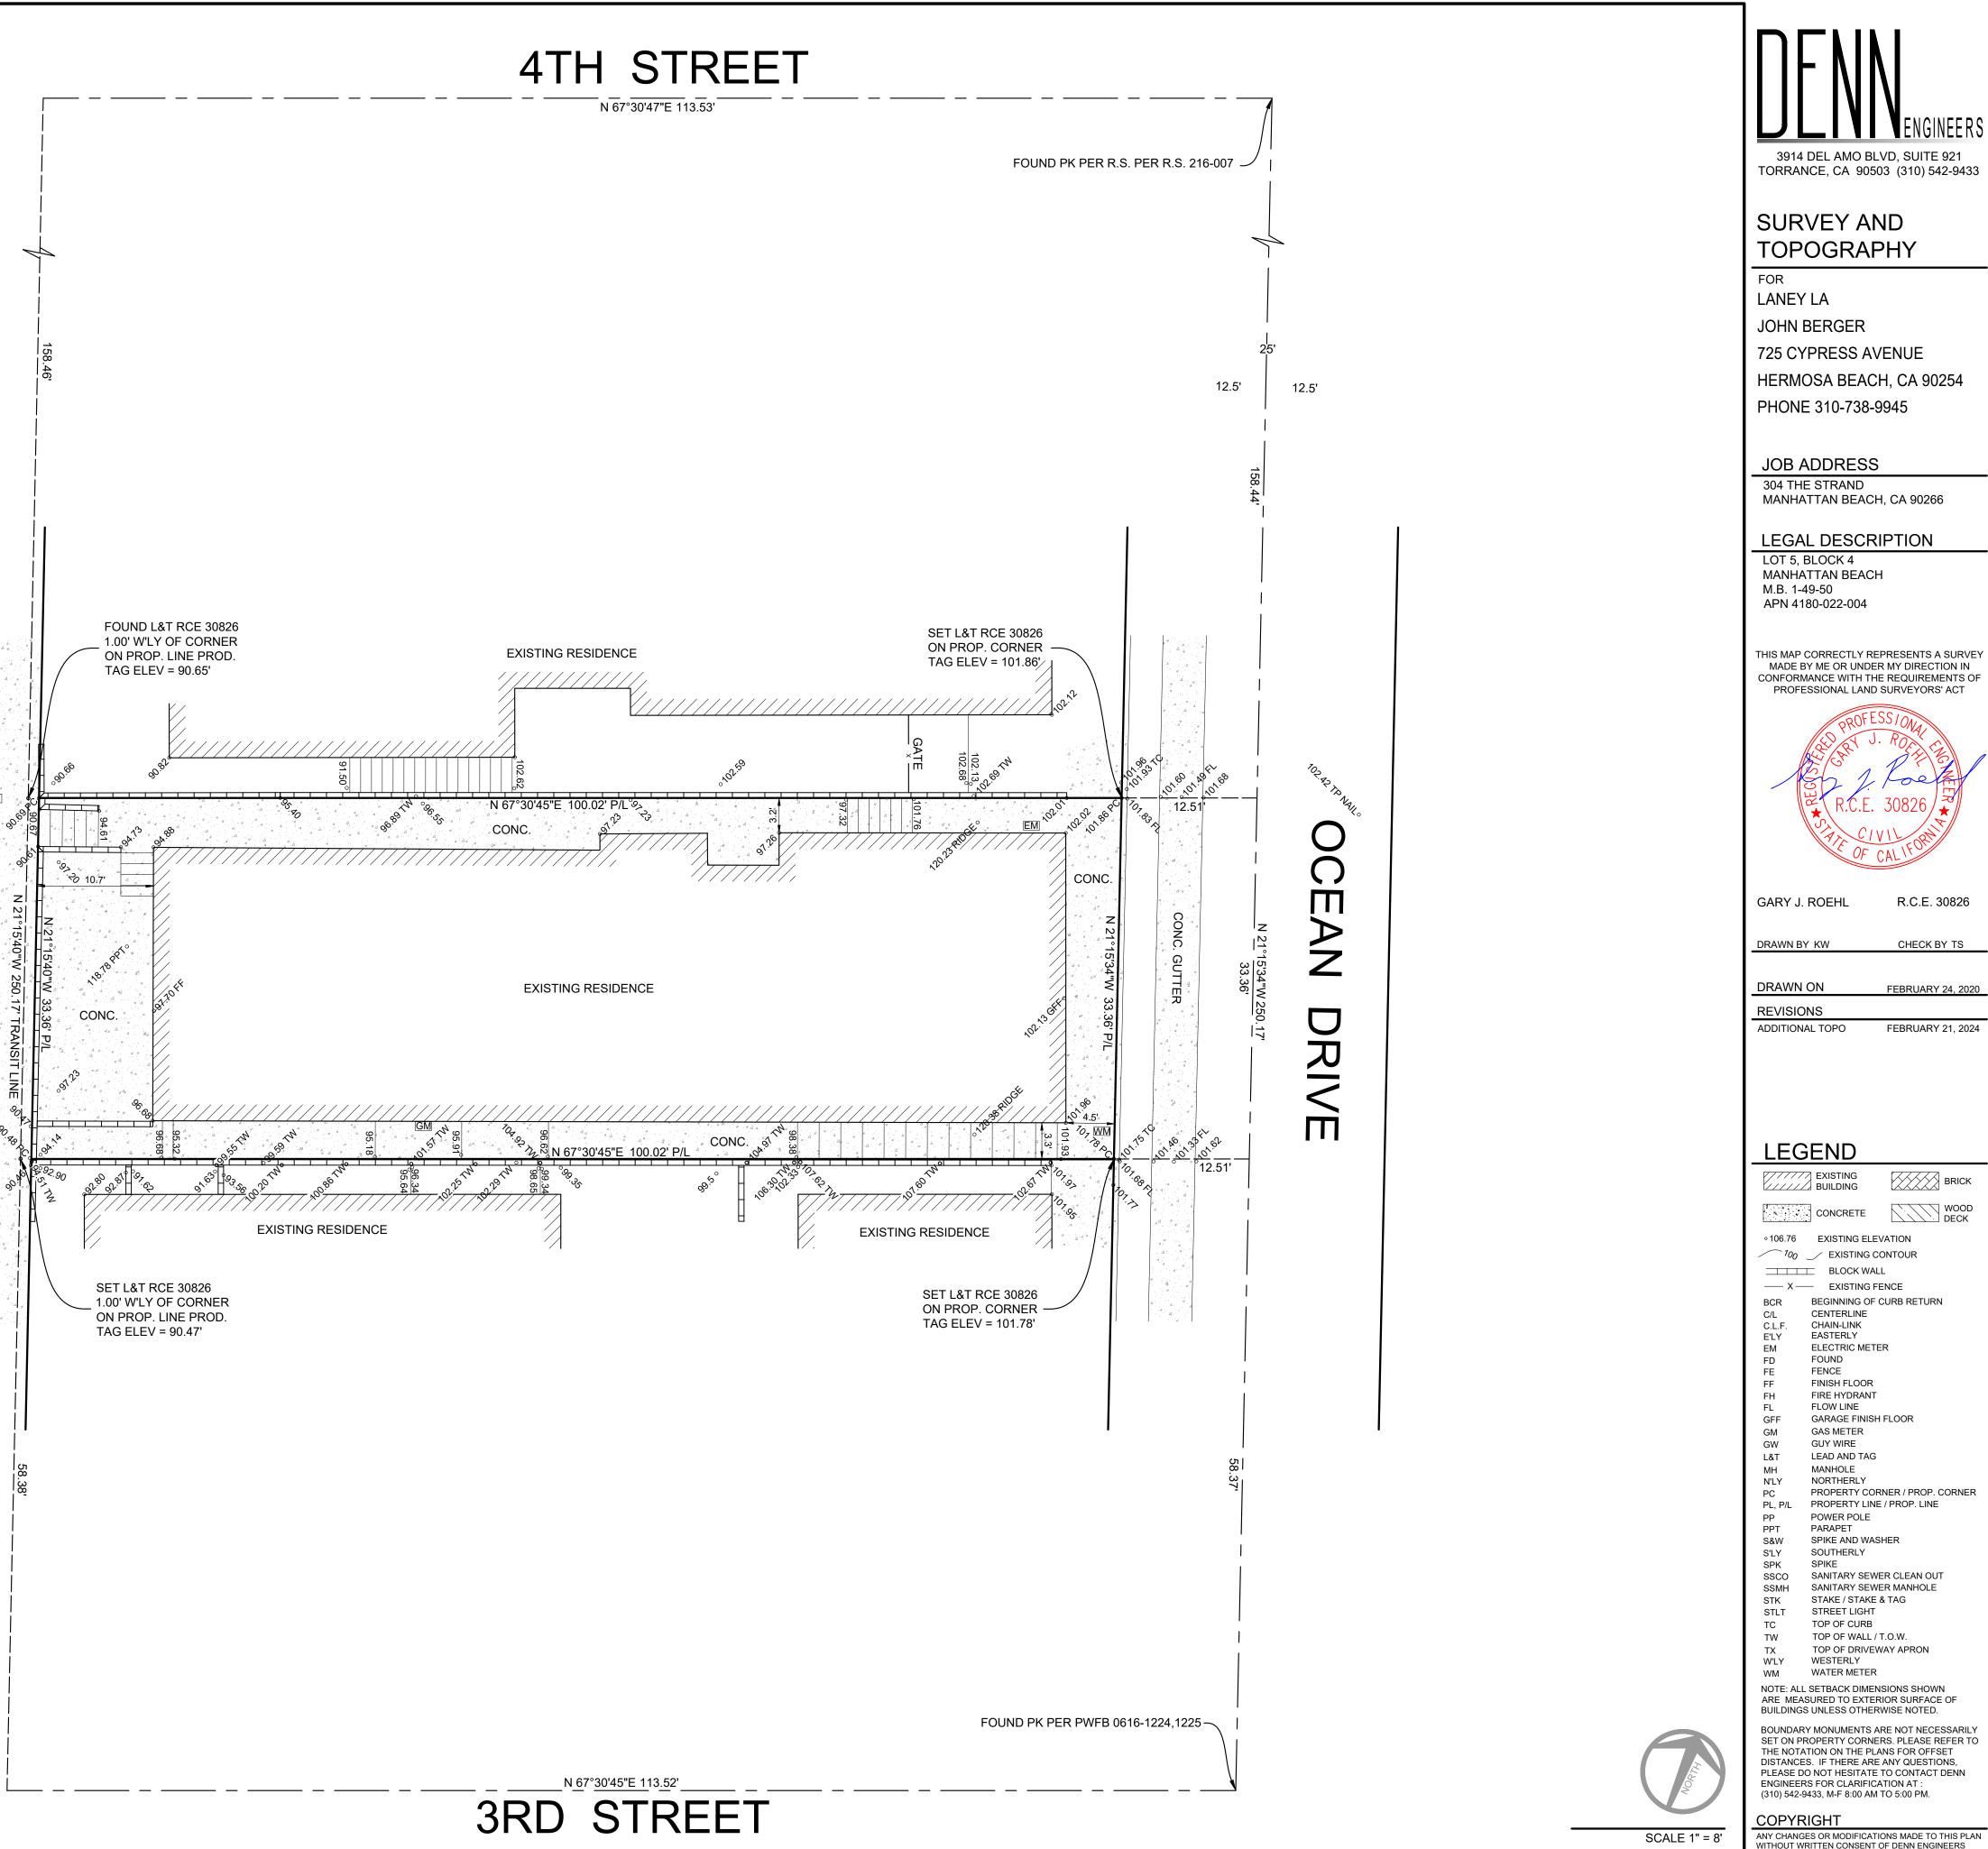
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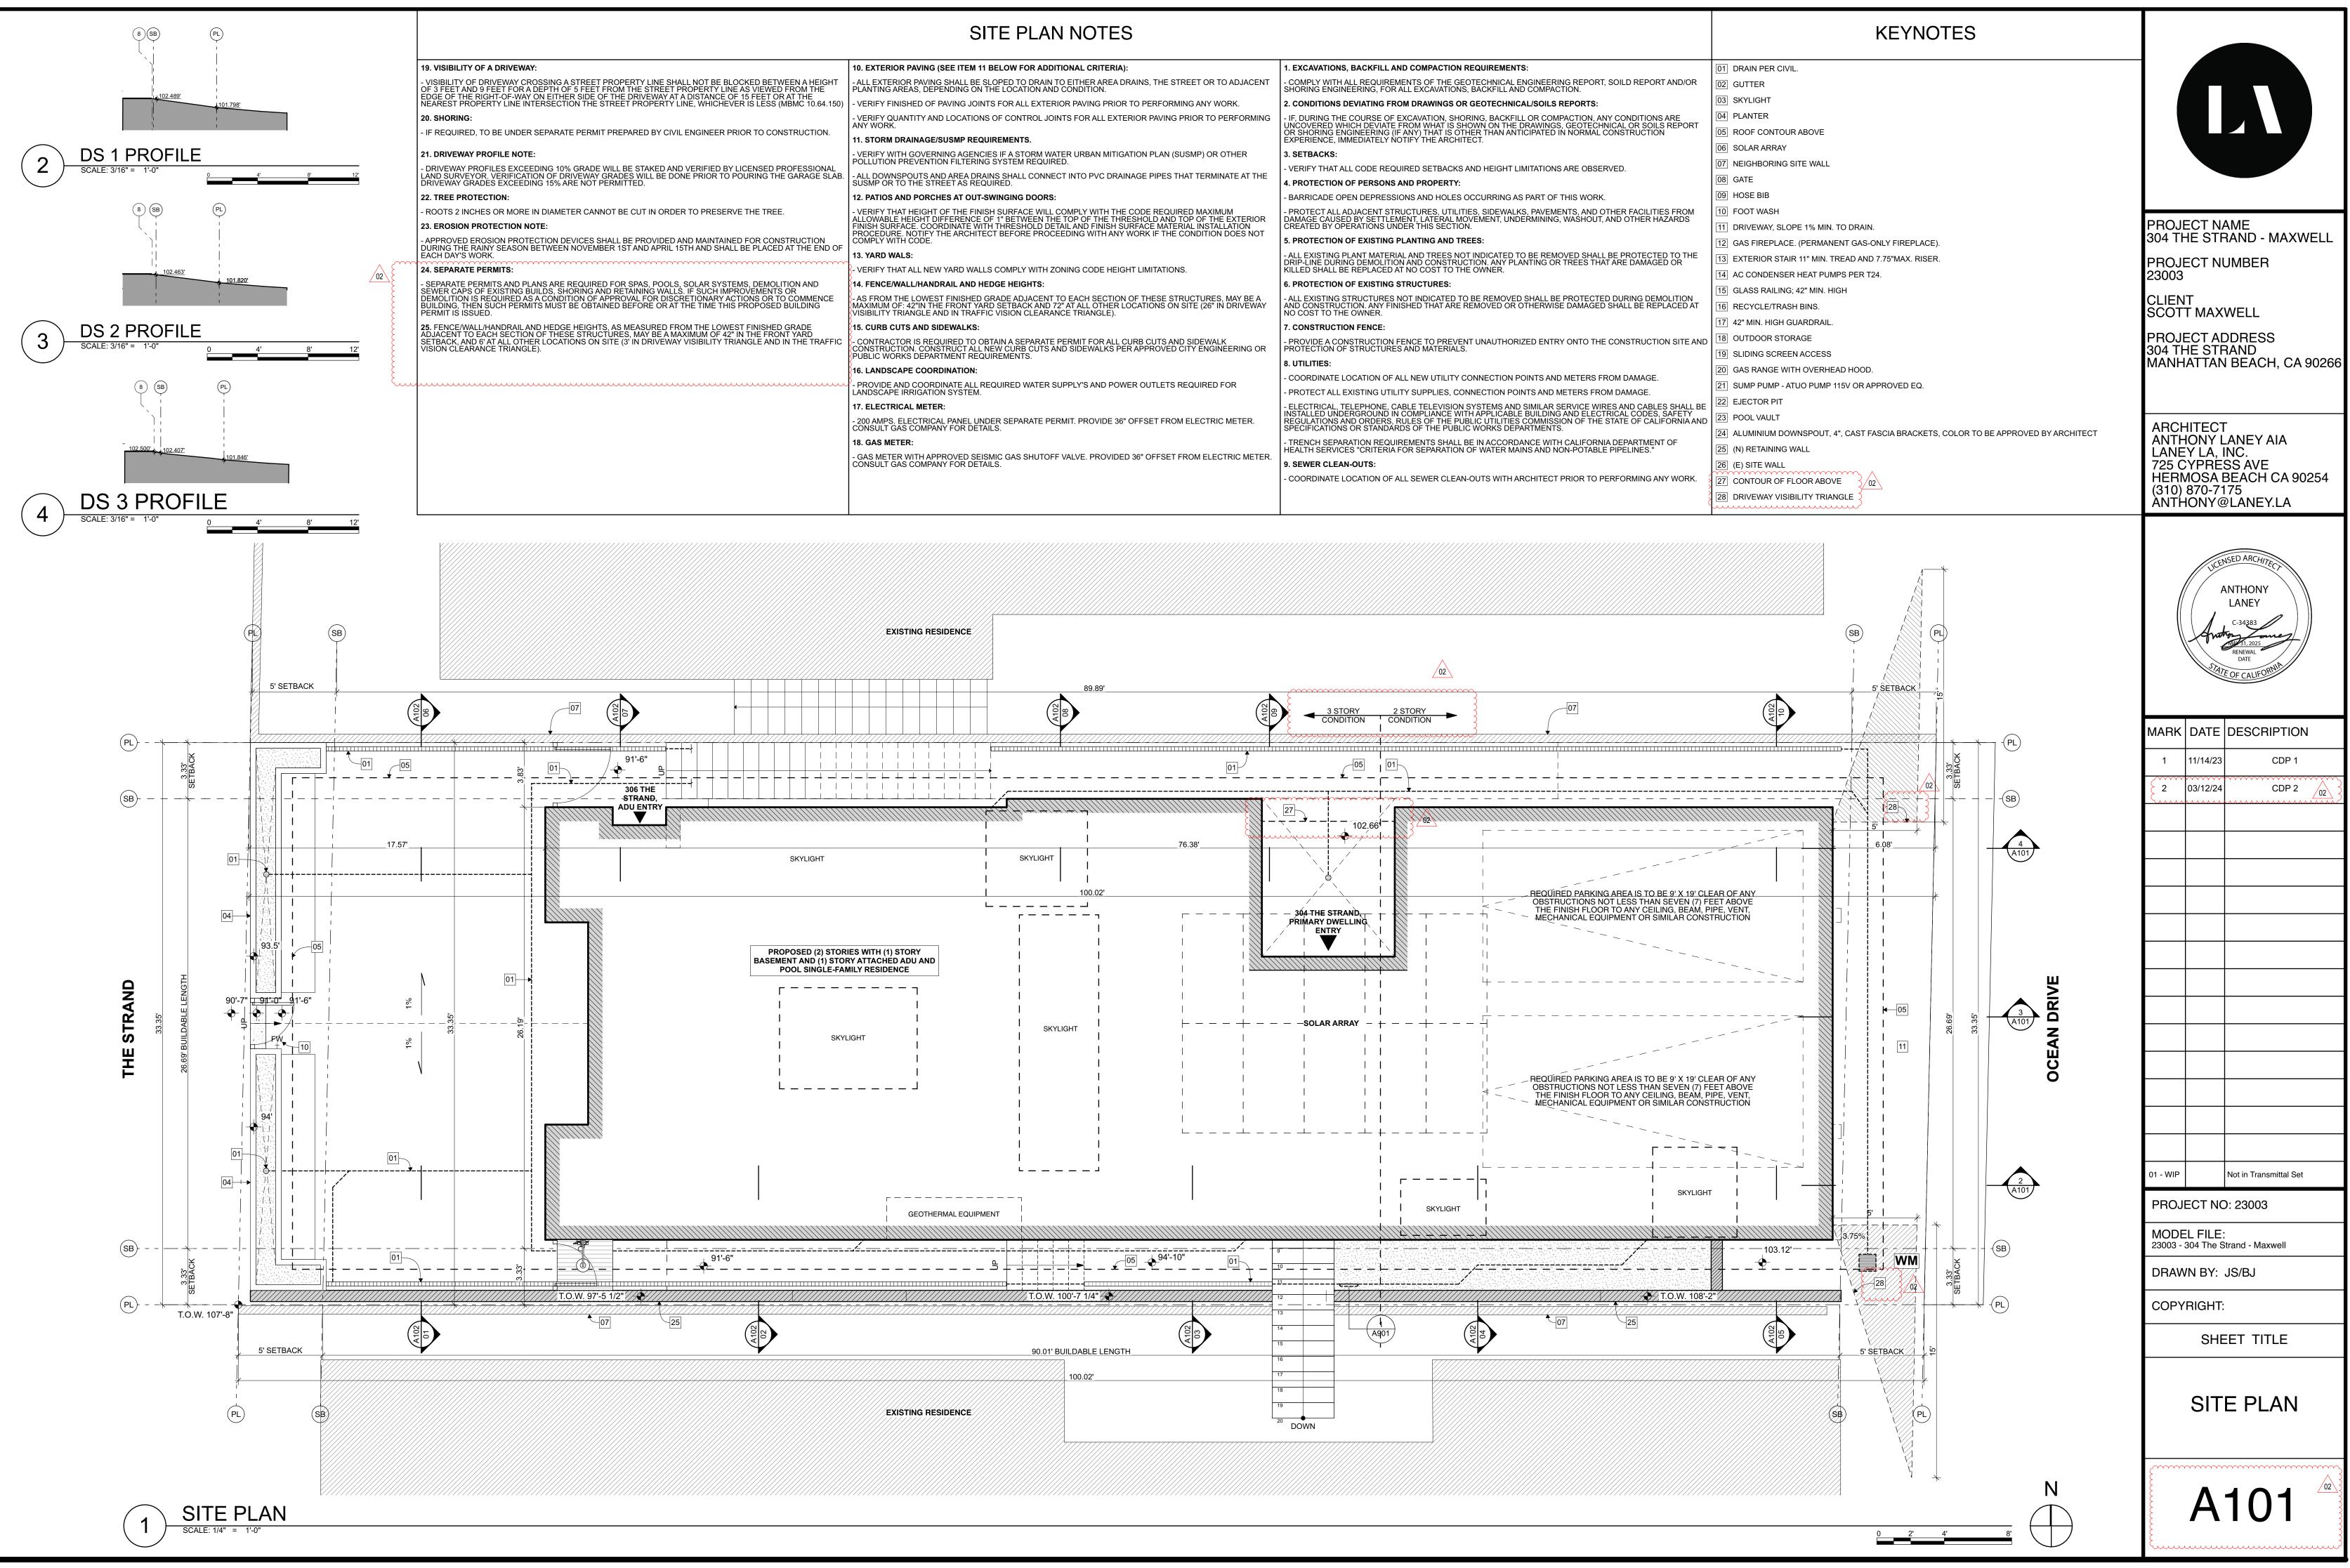

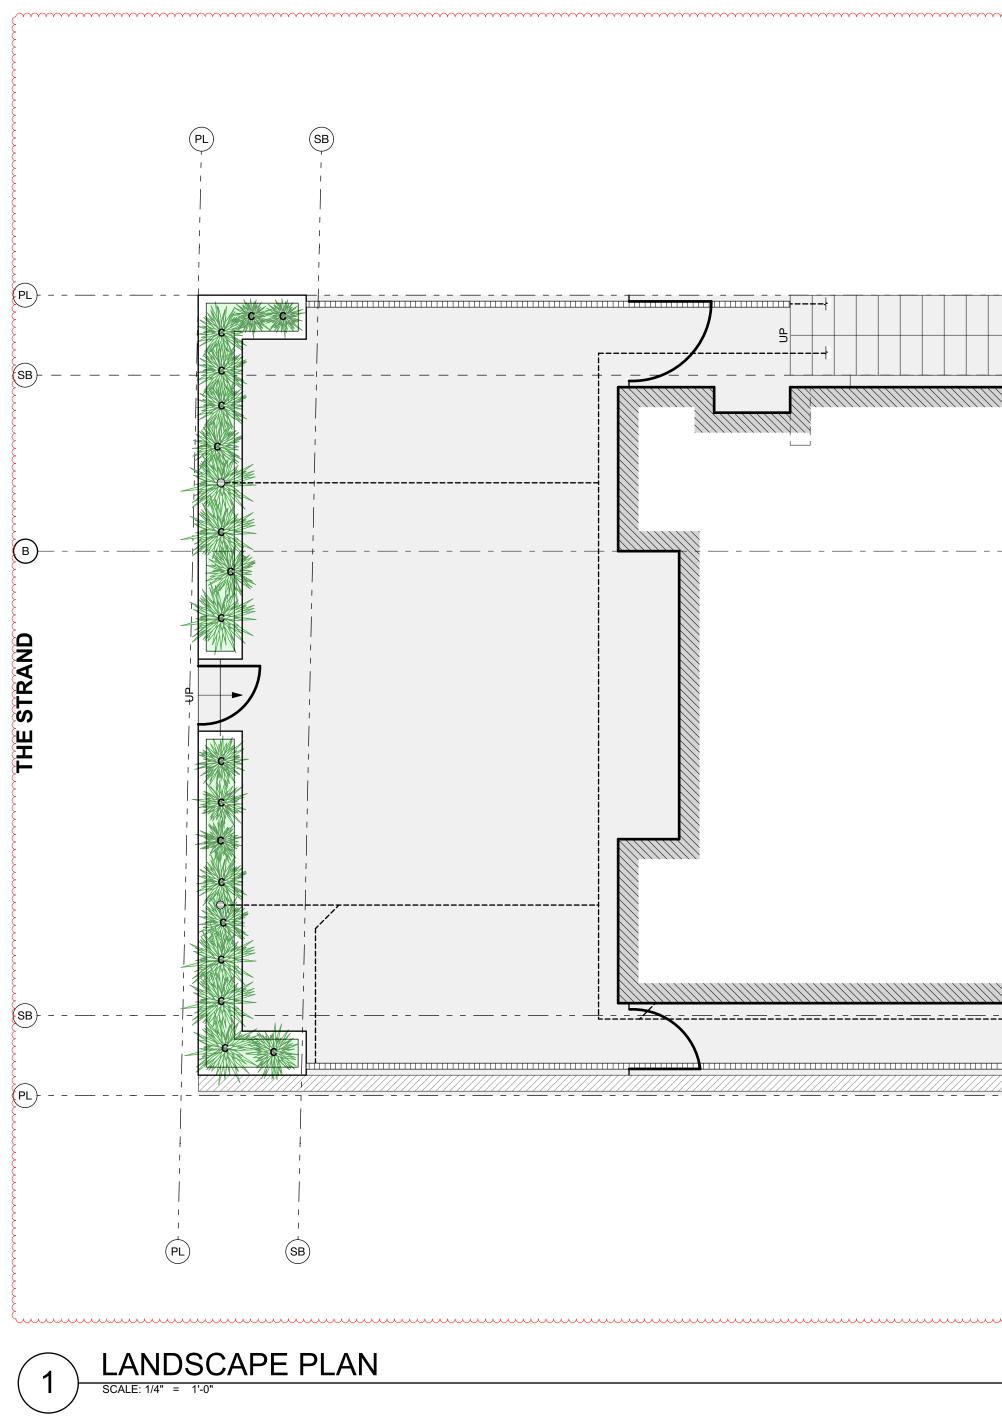
## WATER USAGE:

LOT AREA - 3,336 SF BUILDING FOOTPRINT - 1,886 SF DRIVEWAY - 126 SF LANDSCAPE/HARDSCAPE AREA = LOT - BLDG. FOOTPRINT - DRIVEWAY = 3,336 - 1,886 - 126 = 1,324 SF MAX AREA OF HIGH WATER USE PLANTS = 1,324 x 20% = 264.8 SF PROPOSED AREA < MAXIMUM AREA = 0 SF < 264.8 SF

 <u>+</u>			9	B	B	B	B			
			12							
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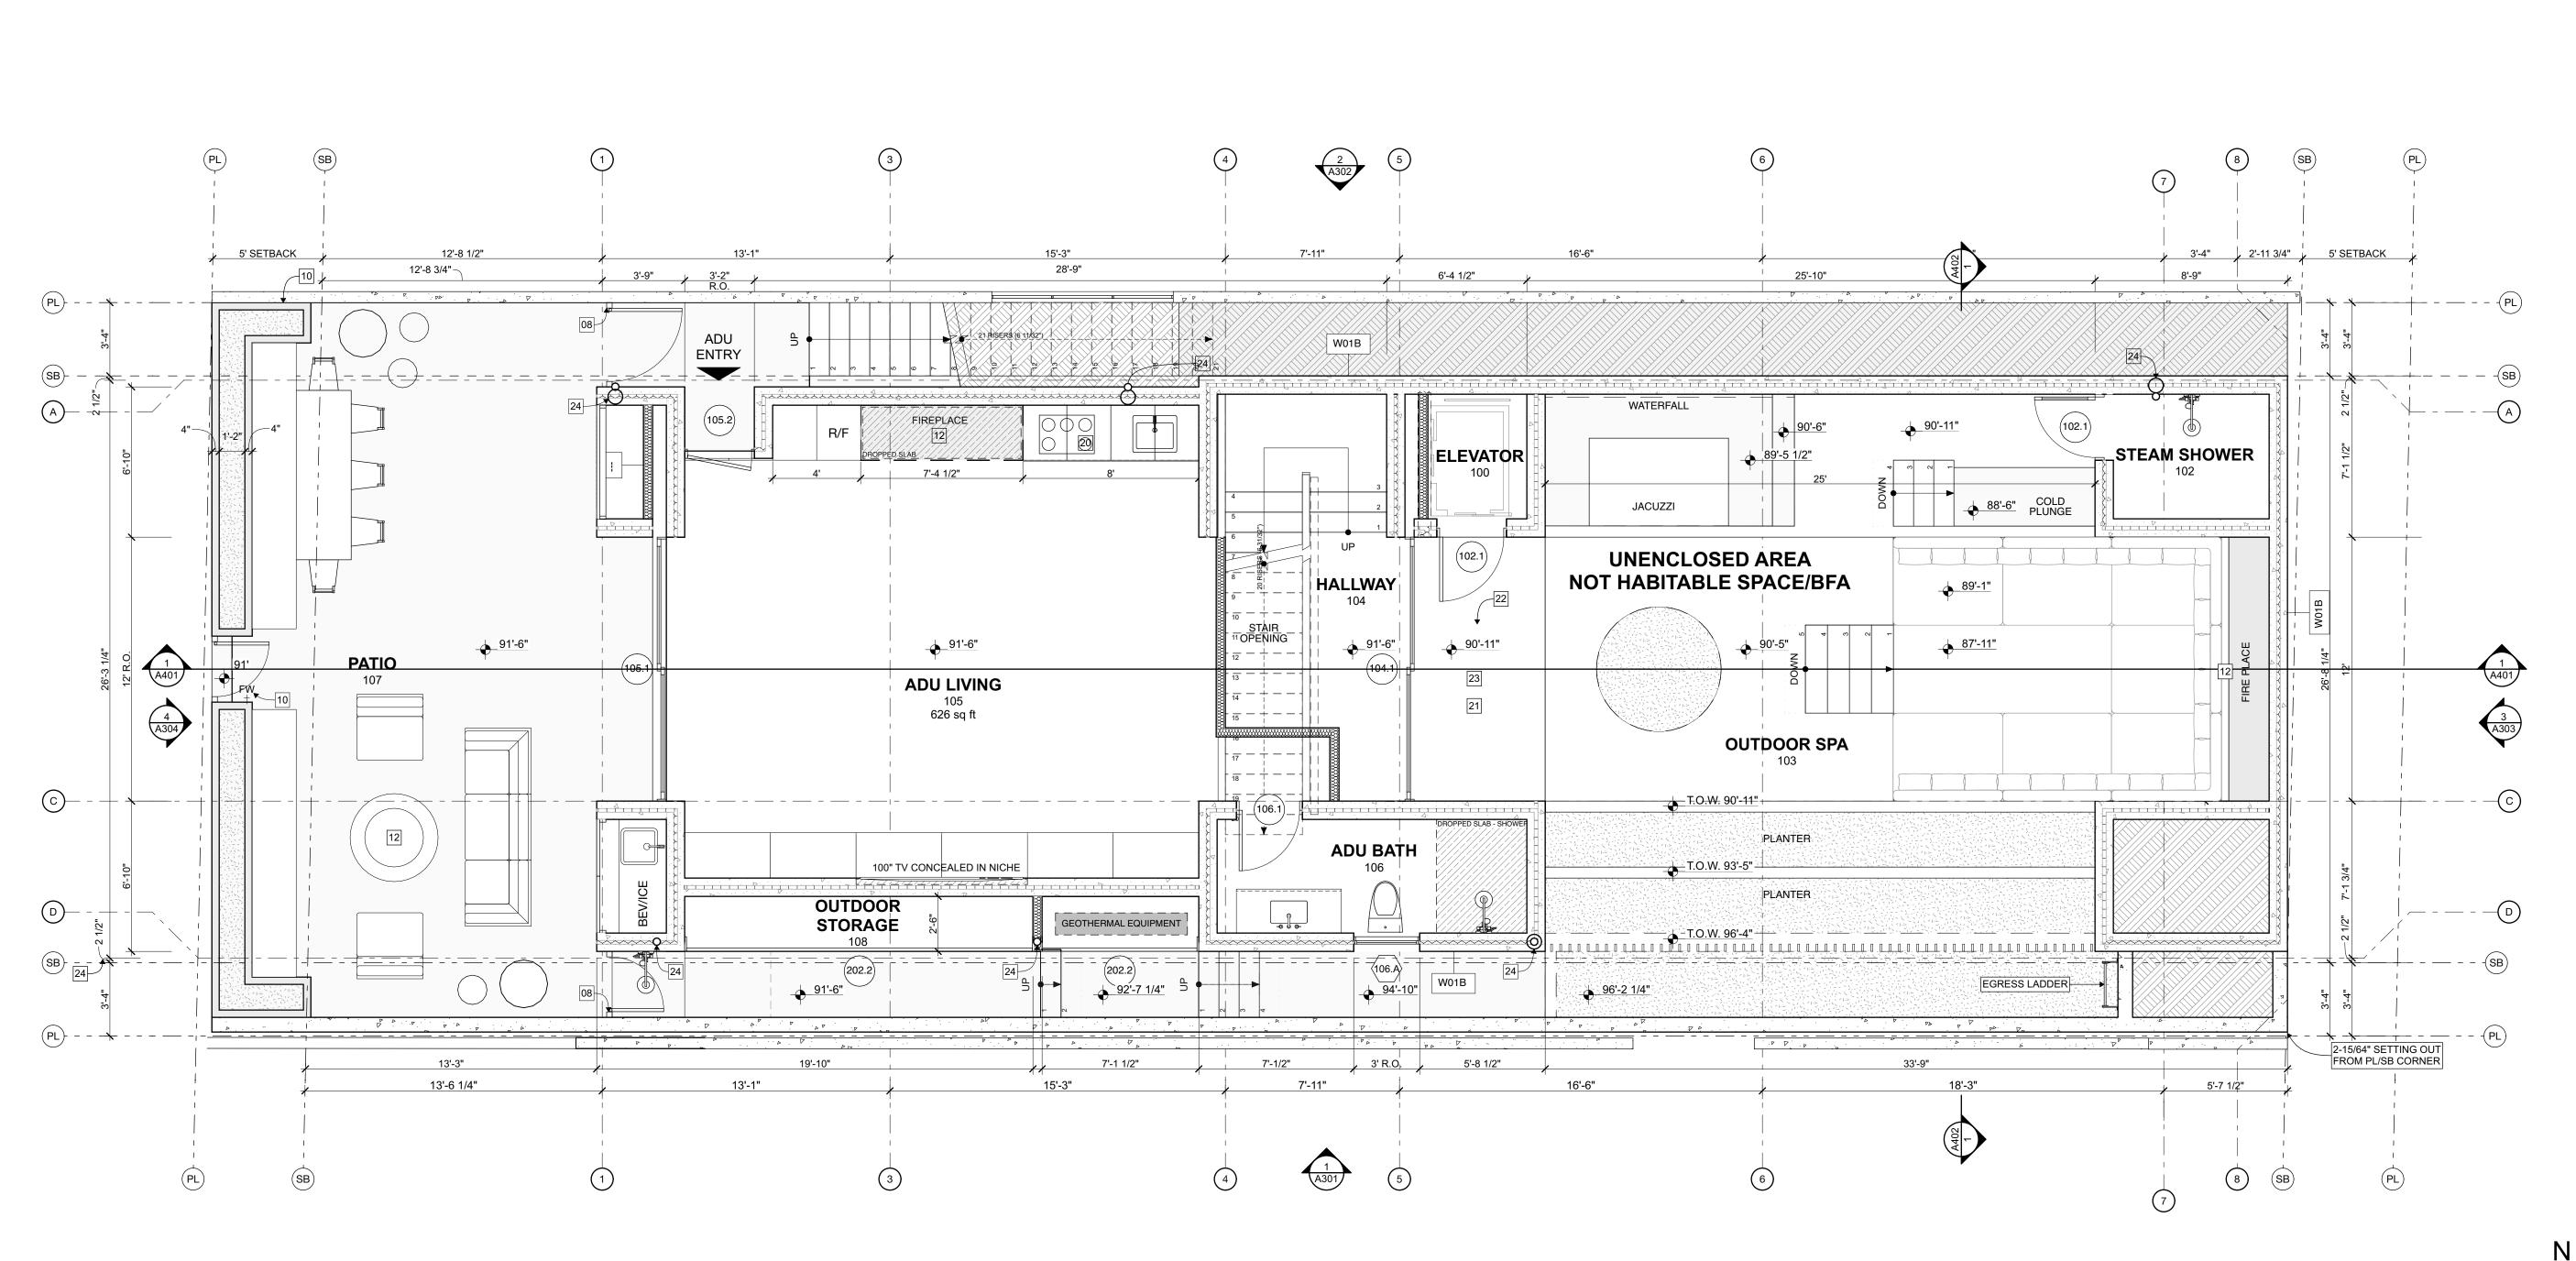


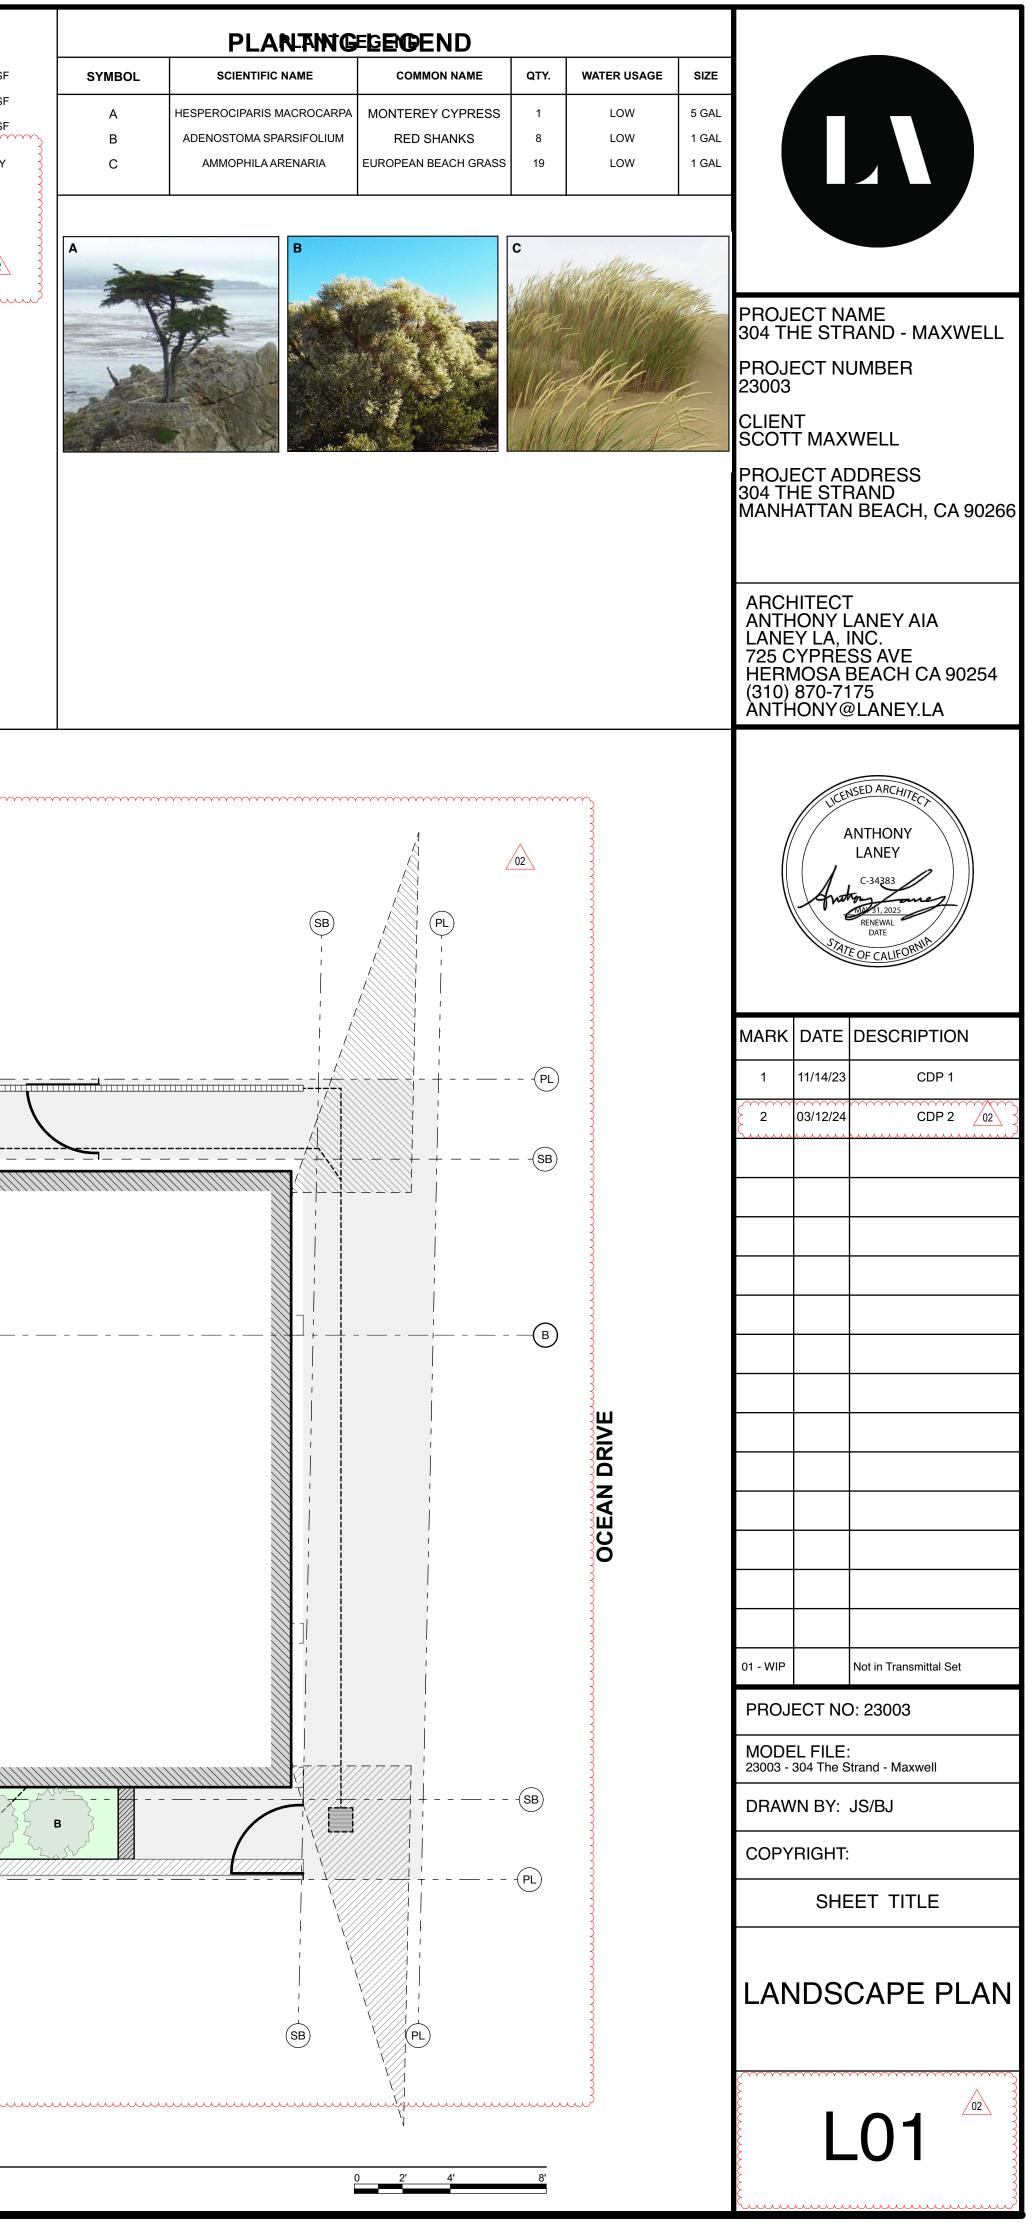


	10. EXTERIOR PAVING (SEE ITEM 11 BELOW FOR ADDITIONAL CRITERIA):	1. EXCAVATIONS, BACKFILL AND COMPACTION REQUIREMENTS:
EN A HEIGHT Rom the I the	- ALL EXTERIOR PAVING SHALL BE SLOPED TO DRAIN TO EITHER AREA DRAINS, THE STREET OR TO ADJACENT PLANTING AREAS, DEPENDING ON THE LOCATION AND CONDITION.	- COMPLY WITH ALL REQUIREMENTS OF THE GEOTECHNICAL ENGINEERING REPORT, SOILD RE SHORING ENGINEERING, FOR ALL EXCAVATIONS, BACKFILL AND COMPACTION.
MC 10.64.150)	- VERIFY FINISHED OF PAVING JOINTS FOR ALL EXTERIOR PAVING PRIOR TO PERFORMING ANY WORK.	2. CONDITIONS DEVIATING FROM DRAWINGS OR GEOTECHNICAL/SOILS REPORTS:
RUCTION.	- VERIFY QUANTITY AND LOCATIONS OF CONTROL JOINTS FOR ALL EXTERIOR PAVING PRIOR TO PERFORMING ANY WORK.	- IF, DURING THE COURSE OF EXCAVATION, SHORING, BACKFILL OR COMPACTION, ANY CONDIT UNCOVERED WHICH DEVIATE FROM WHAT IS SHOWN ON THE DRAWINGS, GEOTECHNICAL OR S
NUCTION.	11. STORM DRAINAGE/SUSMP REQUIREMENTS.	OR SHORING ENGINEERING (IF ANY) THAT IS OTHER THAN ANTICIPATED IN NORMAL CONSTRUCT EXPERIENCE, IMMEDIATELY NOTIFY THE ARCHITECT.
	- VERIFY WITH GOVERNING AGENCIES IF A STORM WATER URBAN MITIGATION PLAN (SUSMP) OR OTHER POLLUTION PREVENTION FILTERING SYSTEM REQUIRED.	3. SETBACKS:
FESSIONAL ARAGE SLAB.	- ALL DOWNSPOUTS AND AREA DRAINS SHALL CONNECT INTO PVC DRAINAGE PIPES THAT TERMINATE AT THE	- VERIFY THAT ALL CODE REQUIRED SETBACKS AND HEIGHT LIMITATIONS ARE OBSERVED.
AINOL OLAD.	SUSMP OR TO THE STREET AS REQUIRED.	4. PROTECTION OF PERSONS AND PROPERTY:
	12. PATIOS AND PORCHES AT OUT-SWINGING DOORS:	- BARRICADE OPEN DEPRESSIONS AND HOLES OCCURRING AS PART OF THIS WORK.
	- VERIFY THAT HEIGHT OF THE FINISH SURFACE WILL COMPLY WITH THE CODE REQUIRED MAXIMUM ALLOWABLE HEIGHT DIFFERENCE OF 1" BETWEEN THE TOP OF THE THRESHOLD AND TOP OF THE EXTERIOR FINISH SURFACE. COORDINATE WITH THRESHOLD DETAIL AND FINISH SURFACE MATERIAL INSTALLATION PROCEDURE. NOTIFY THE ARCHITECT BEFORE PROCEEDING WITH ANY WORK IF THE CONDITION DOES NOT	- PROTECT ALL ADJACENT STRUCTURES, UTILITIES, SIDEWALKS, PAVEMENTS, AND OTHER FAC DAMAGE CAUSED BY SETTLEMENT, LATERAL MOVEMENT, UNDERMINING, WASHOUT, AND OTHE CREATED BY OPERATIONS UNDER THIS SECTION.
RUCTION	COMPLY WITH CODE.	5. PROTECTION OF EXISTING PLANTING AND TREES:
	13. YARD WALS:	- ALL EXISTING PLANT MATERIAL AND TREES NOT INDICATED TO BE REMOVED SHALL BE PRODUCE DRIP-LINE DURING DEMOLITION AND CONSTRUCTION. ANY PLANTING OR TREES THAT ARE D
	- VERIFY THAT ALL NEW YARD WALLS COMPLY WITH ZONING CODE HEIGHT LIMITATIONS.	KILLED SHALL BE REPLACED AT NO COST TO THE OWNER.
ON AND	14. FENCE/WALL/HANDRAIL AND HEDGE HEIGHTS:	6. PROTECTION OF EXISTING STRUCTURES:
OMMENCE JILDING	- AS FROM THE LOWEST FINISHED GRADE ADJACENT TO EACH SECTION OF THESE STRUCTURES, MAY BE A MAXIMUM OF: 42"IN THE FRONT YARD SETBACK AND 72" AT ALL OTHER LOCATIONS ON SITE (26" IN DRIVEWAY VISIBILITY TRIANGLE AND IN TRAFFIC VISION CLEARANCE TRIANGLE).	- ALL EXISTING STRUCTURES NOT INDICATED TO BE REMOVED SHALL BE PROTECTED DURING AND CONSTRUCTION. ANY FINISHED THAT ARE REMOVED OR OTHERWISE DAMAGED SHALL BE NO COST TO THE OWNER.
RADE YARD	15. CURB CUTS AND SIDEWALKS:	7. CONSTRUCTION FENCE:
THE TRAFFIC	- CONTRACTOR IS REQUIRED TO OBTAIN A SEPARATE PERMIT FOR ALL CURB CUTS AND SIDEWALK CONSTRUCTION. CONSTRUCT ALL NEW CURB CUTS AND SIDEWALKS PER APPROVED CITY ENGINEERING OR PUBLIC WORKS DEPARTMENT REQUIREMENTS.	- PROVIDE A CONSTRUCTION FENCE TO PREVENT UNAUTHORIZED ENTRY ONTO THE CONSTRU PROTECTION OF STRUCTURES AND MATERIALS.
	16. LANDSCAPE COORDINATION:	8. UTILITIES:
mmm	- PROVIDE AND COORDINATE ALL REQUIRED WATER SUPPLY'S AND POWER OUTLETS REQUIRED FOR	- COORDINATE LOCATION OF ALL NEW UTILITY CONNECTION POINTS AND METERS FROM DAMA
	LANDSCAPE IRRIGATION SYSTEM.	- PROTECT ALL EXISTING UTILITY SUPPLIES, CONNECTION POINTS AND METERS FROM DAMAG
	17. ELECTRICAL METER:	- ELECTRICAL, TELEPHONE, CABLE TELEVISION SYSTEMS AND SIMILAR SERVICE WIRES AND CA INSTALLED UNDERGROUND IN COMPLIANCE WITH APPLICABLE BUILDING AND ELECTRICAL COM
	- 200 AMPS. ELECTRICAL PANEL UNDER SEPARATE PERMIT. PROVIDE 36" OFFSET FROM ELECTRIC METER. CONSULT GAS COMPANY FOR DETAILS.	REGULATIONS AND ORDERS, RULES OF THE PUBLIC UTILITIES COMMISSION OF THE STATE OF SPECIFICATIONS OR STANDARDS OF THE PUBLIC WORKS DEPARTMENTS.
	18. GAS METER:	- TRENCH SEPARATION REQUIREMENTS SHALL BE IN ACCORDANCE WITH CALIFORNIA DEPARTI HEALTH SERVICES "CRITERIA FOR SEPARATION OF WATER MAINS AND NON-POTABLE PIPELINE
	- GAS METER WITH APPROVED SEISMIC GAS SHUTOFF VALVE. PROVIDED 36" OFFSET FROM ELECTRIC METER. CONSULT GAS COMPANY FOR DETAILS.	9. SEWER CLEAN-OUTS:
		- COORDINATE LOCATION OF ALL SEWER CLEAN-OUTS WITH ARCHITECT PRIOR TO PERFORMIN

# **GENERAL NOTES**

LIGHT AND VENTILATION NOTES SINGLE FAMILY RESIDENCE AND ACCESSORY DWELLING UNIT SHALL EACH HAVE A WHOLE BUILDING VENTILATION SYSTEM USING THE CENTRAL HVAC SYSTEM OR A DEDICATED EXHAUST FAN - PER SECTION 150.0(O).DEDICATED VENTILATION AIR DUCT TO CONNECT TO RETURN PLENUM OF THE AIR HANDLER AND GENERAL NOTES 1. VERIFY SHEAR WALL LOCATION PER STRUCTURAL, SUB 15/32" SHEAR PANEL FOR 1/2" PLYWOOD 2. VERIFY INSULATION PER LOCATION AS DESCRIBED IN T-24 O THE DWELLING EXTERIOR. IMPERVIOUS SURFACE SHALL BE SLOPED AWAY FROM THE BUILDING AT 2% MINIMUM SLOPE FOR A CERTIFICATE OF VERIFICATION (CF3R) SHALL BE COMPLETED, REGISTERED AND SIGNED/CERTIFIED BY THE HERS RATER. THE REGISTERED CF3R FORM SHALL BE MADE AVAILABLE TO THE BUILDING DEPARTMENT AND BUILDER. MINIMUM DISTANCE OF 10 FEET; LOT SHALL BE GRADED TO DRAIN SURFACE WATER AWAY FROM FOUNDATION WALLS - PER C.R.C. SECTION R401.3. 4. FIRE RESISTANCE-RATED EXTERIOR WALL CONSTRUCTION SHALL BE MAINTAINED THROUGH CRAWL SPACE, FLOOR FRAMING, AND ATTIC SPACES IN ACCORDANCE WITH 705.6 CBC. PER CRC R303.1-1: MECHANICAL VENTILATION SYSTEM CAPABLE OF PRODUCING 0.35 AIR CHANGES PER JOINTS INSTALLED IN OR BETWEEN FIRE-RESISTANCE-RATED WALLS, FLOORS OR FLOOR/CEILING ASSEMBLIES AND ROOFS OR ROOF/CEILING ASSEMBLIES SHALL BE PROTECTED BY AN APPROVED FIRE-RESISTANT JOINST SYSTEM WITH A FIRE-RESISTANCE RATING NOT LESS THAN THAT OF THE ASSEMBLY IN HOUR IN THE HABITABLE ROOMS IS INSTALLED IN ACCORDANCE WITH THE CALIFORNIA MECHANICAL CODE. FIRE SAFETY NOTES: A) AUTOMATIC RESIDENTIAL FIRE SPRINKLER SYSTEM SHALL BE INSTALLED IN THE DWELLING AND IN OTHER AREAS AS REQUIRED BY THE FIRE CODE OFFICIAL. [CRC R313, CFC 903.2.8.2 & MBMC 3.16.020] WHICH IT IS INSTALLED. 6. ELECTRICAL RECEPTACLE OUTLETS, SWITCHES AND CONTROLS (INCLUDING CONTROLS FOR HEATING, VENTILATION AND AIR CONDITIONING) INTENDED TO BE USED BY OCCUPANTS SHALL BE LOCATED NO MORE 3) AUTOMATIC RESIDENTIAL FIRE SPRINKLERS SHALL COMPLY WITH THE MANHATTAN BEACH FIRE THAN 48 INCHES (1219.2 MM) MEASURED FROM THE TOP OF THE OUTLET BOX AND NOT LESS THAN 15 DEPARTMENT MINIMUM REQUIREMENTS FOR NFPA 13D FIRE SPRINKLER SYSTEMS INCHES (381 MM) MEASURED FROM THE BOTTOM OF THE OUTLET BOX ABOVE THE FINISH FLOOR. (PER C) FIRE SPRINKLERS SHALL BE UNDER SEPARATE PLAN CHECK AND PERMIT D) HORN/STROBE ALARM DEVICE SHALL BE PLACE ON THE ADDRESS SIDE OF THE BUILDING UNLESS OTHERWISE SPECIFIED BY FIRE DEPARTMENT PERSONNEL R327.1.2.) EROSION PROTECTION NOTE: APPROVED EROSION PROTECTION DEVICES SHALL BE PROVIDED AND MAINTAINED FOR CONSTRUCTION ELECTRICAL NOTES: A) PENETRATIONS OF ELECTRICAL OUTLET BOXES IN COMMON WALLS BETWEEN DWELLING UNITS, SHALL DURING THE RAINY SEASON BETWEEN NOVEMBER 1ST AND APRIL 15TH AND SHALL BE PLACED AT THE END OF EACH DAY'S WORK. BÉ PROTECTED. (CRC R302.4) BE PROTECTED. (CRC R302.4) B) ALL ABOVE-GROUND EXTERIOR CONDUIT MUST BE RIGID GALVANIZED STEEL OR SCHEDULE 80 SUNLIGHT-RESISTANT NON METALLIC CONDUIT PER MBMC 9.12.050 ENERGY NOTES CERTIFICATE OF INSTALLATION (CF2R-ENV, CF2R-LTG AND CF2R-MECH) SHALL BE COMPLETED BY THE C) ALL CONDUCTORS SHALL BE OF COPPER PER MBMC 9.12.060 APPLICABLE CONTRACTORS INSTALLING ENERGY FEATURES. WHEN COMPLIANCE REQUIRES HERS FIELD VERIFICATION AND/OR TESTING, ALL CF2R FORMS SHALL BE SUBMITTED ELECTRONICALLY TO AN PLUMBING NOTES: APPROVED HERS PROVIDER DATA REGISTRY. THE CF2R FORMS SHALL BE POSTED AT THE JOB SITE IN A ALL PLUMBING FIXTURES AND FITTINGS SHALL COMPLY WITH THE FOLLOWING MAXIMUN FLOWRATES: (CGBSC 4.303.1) A) WATER CLOSETS 1.28 GALLONS/FLUSH CONSPICUOUS LOCATION. DIMENSION NOTES 3) SHOWERHEADS-SINGLE C) SHOWERHEADS-MULT. A) ALL DIMENSIONS TO F.O.STUD UNLESS OTHERWISE NOTED. B) ALL SPOT ELEVATIONS TO F.SLAB UNLESS OTHERWISE NOTED. 1.8 gpm @ 80 PSI 1.8 gpm @ 80 PSI COMB. D) LAVATORY FAUCETS E) KITCHEN FAUCETS 1.2 gpm @ 60 PSI 1.5 gpm @ 60 PSI - SEPARATE PERMITS AND PLANS ARE REQUIRED FOR SPAS, POOLS, SOLAR SYSTEMS, DEMOLITION AND SEWER CAPS OF EXISTING BUILDS, SHORING AND RETAINING WALLS. IF SUCH IMPROVEMENTS OR DEMOLITION IS REQUIRED AS A CONDITION OF APPROVAL FOR DISCRETIONARY ACTIONS OR TO COMMENCE BUILDING, THEN SUCH PERMITS MUST BE OBTAINED BEFORE OR AT THE TIME THIS PROPOSED BUILDING PERMIT IS ISSUED. - FENCE/WALL/HANDRAIL AND HEDGE HEIGHTS, AS MEASURED FROM THE LOWEST FINISHED GRADE ADJACENT TO EACH SECTION OF THESE STRUCTURES, MAY BE A MAXIMUM OF 42" IN THE FRONT YARD SETBACK, AND 6' AT ALL OTHER LOCATIONS ON SITE (3' IN DRIVEWAY VISIBILITY TRIANGLE AND IN THE TRAFFIC VISION CLEARANCE TRIANGLE).



SCALE: 1/4" = 1'-0"

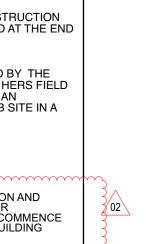

## **KEYNOTES**

- 01 DRAIN PER CIVIL. 02 GUTTER 03 SKYLIGHT 04 PLANTER 05 ROOF CONTOUR ABOVE 06 SOLAR ARRAY 07 NEIGHBORING SITE WALL
- 08 GATE 09 HOSE BIB
- 10 FOOT WASH
- 11 DRIVEWAY, SLOPE 1% MIN. TO DRAIN.
- [12] GAS FIREPLACE. (PERMANENT GAS-ONLY FIREPLACE).
- [13] EXTERIOR STAIR 11" MIN. TREAD AND 7.75"MAX. RISER.
- 14 AC CONDENSER HEAT PUMPS PER T24.
- 15 GLASS RAILING; 42" MIN. HIGH
- 16 RECYCLE/TRASH BINS.
- 17 42" MIN. HIGH GUARDRAIL
- 18 OUTDOOR STORAGE
- 19 SLIDING SCREEN ACCESS
- [20] GAS RANGE WITH OVERHEAD HOOD.
- 21 SUMP PUMP ATUO PUMP 115V OR APPROVED EQ.
- 22 EJECTOR PIT
- 23 POOL VAULT
- [24] ALUMINIUM DOWNSPOUT, 4", CAST FASCIA BRACKETS, COLOR TO BE APPROVED BY ARCHITECT

0 2' 4'


- [25] (N) RETAINING WALL
- [26] (E) SITE WALL 27 CONTOUR OF FLOOR ABOVE
- 28 DRIVEWAY VISIBILITY TRIANGLE

PROJECT NAME 304 THE STRAND - MAXWELL PROJECT NUMBER 23003 CLIENT SCOTT MAXWELL PROJECT ADDRESS 304 THE STRAND MANHATTAN BEACH, CA 90266 ARCHITECT ANTHONY LANEY AIA LANEY LA, INC. 725 CYPRESS AVE HERMOSA BEACH CA 90254 (310) 870-7175 ÀNTHONY@LANEY.LA ENSED ARCH ANTHONY LANEY MARK DATE DESCRIPTION

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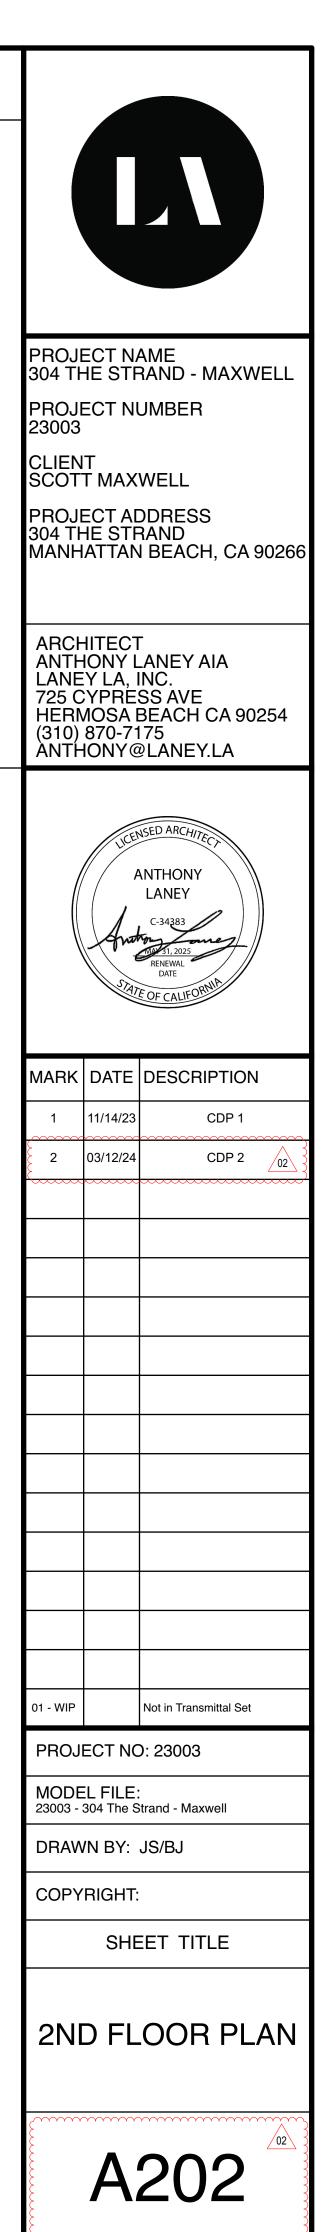
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	BE PLACE ON THE ADDRESS SIDE OF THE BUILDING UNLESS	······
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(CGBSC 4.303.1)		
A) WATER CLOSETS	1.28 GALLONS/FLUSH	DIMENSION NOTES
B) SHOWERHEADS-SINGLE	1.8 gpm @ 80 PSI	A) ALL DIMENSIONS TO F.O.STUD UNLESS OTHERWISE NOTED.
C) SHOWERHEADS-MULT.	1.8 gpm @ 80 PSI COMB.	B) ALL SPOT ELEVATIONS TO F.SLAB UNLESS OTHERWISE NOTED.
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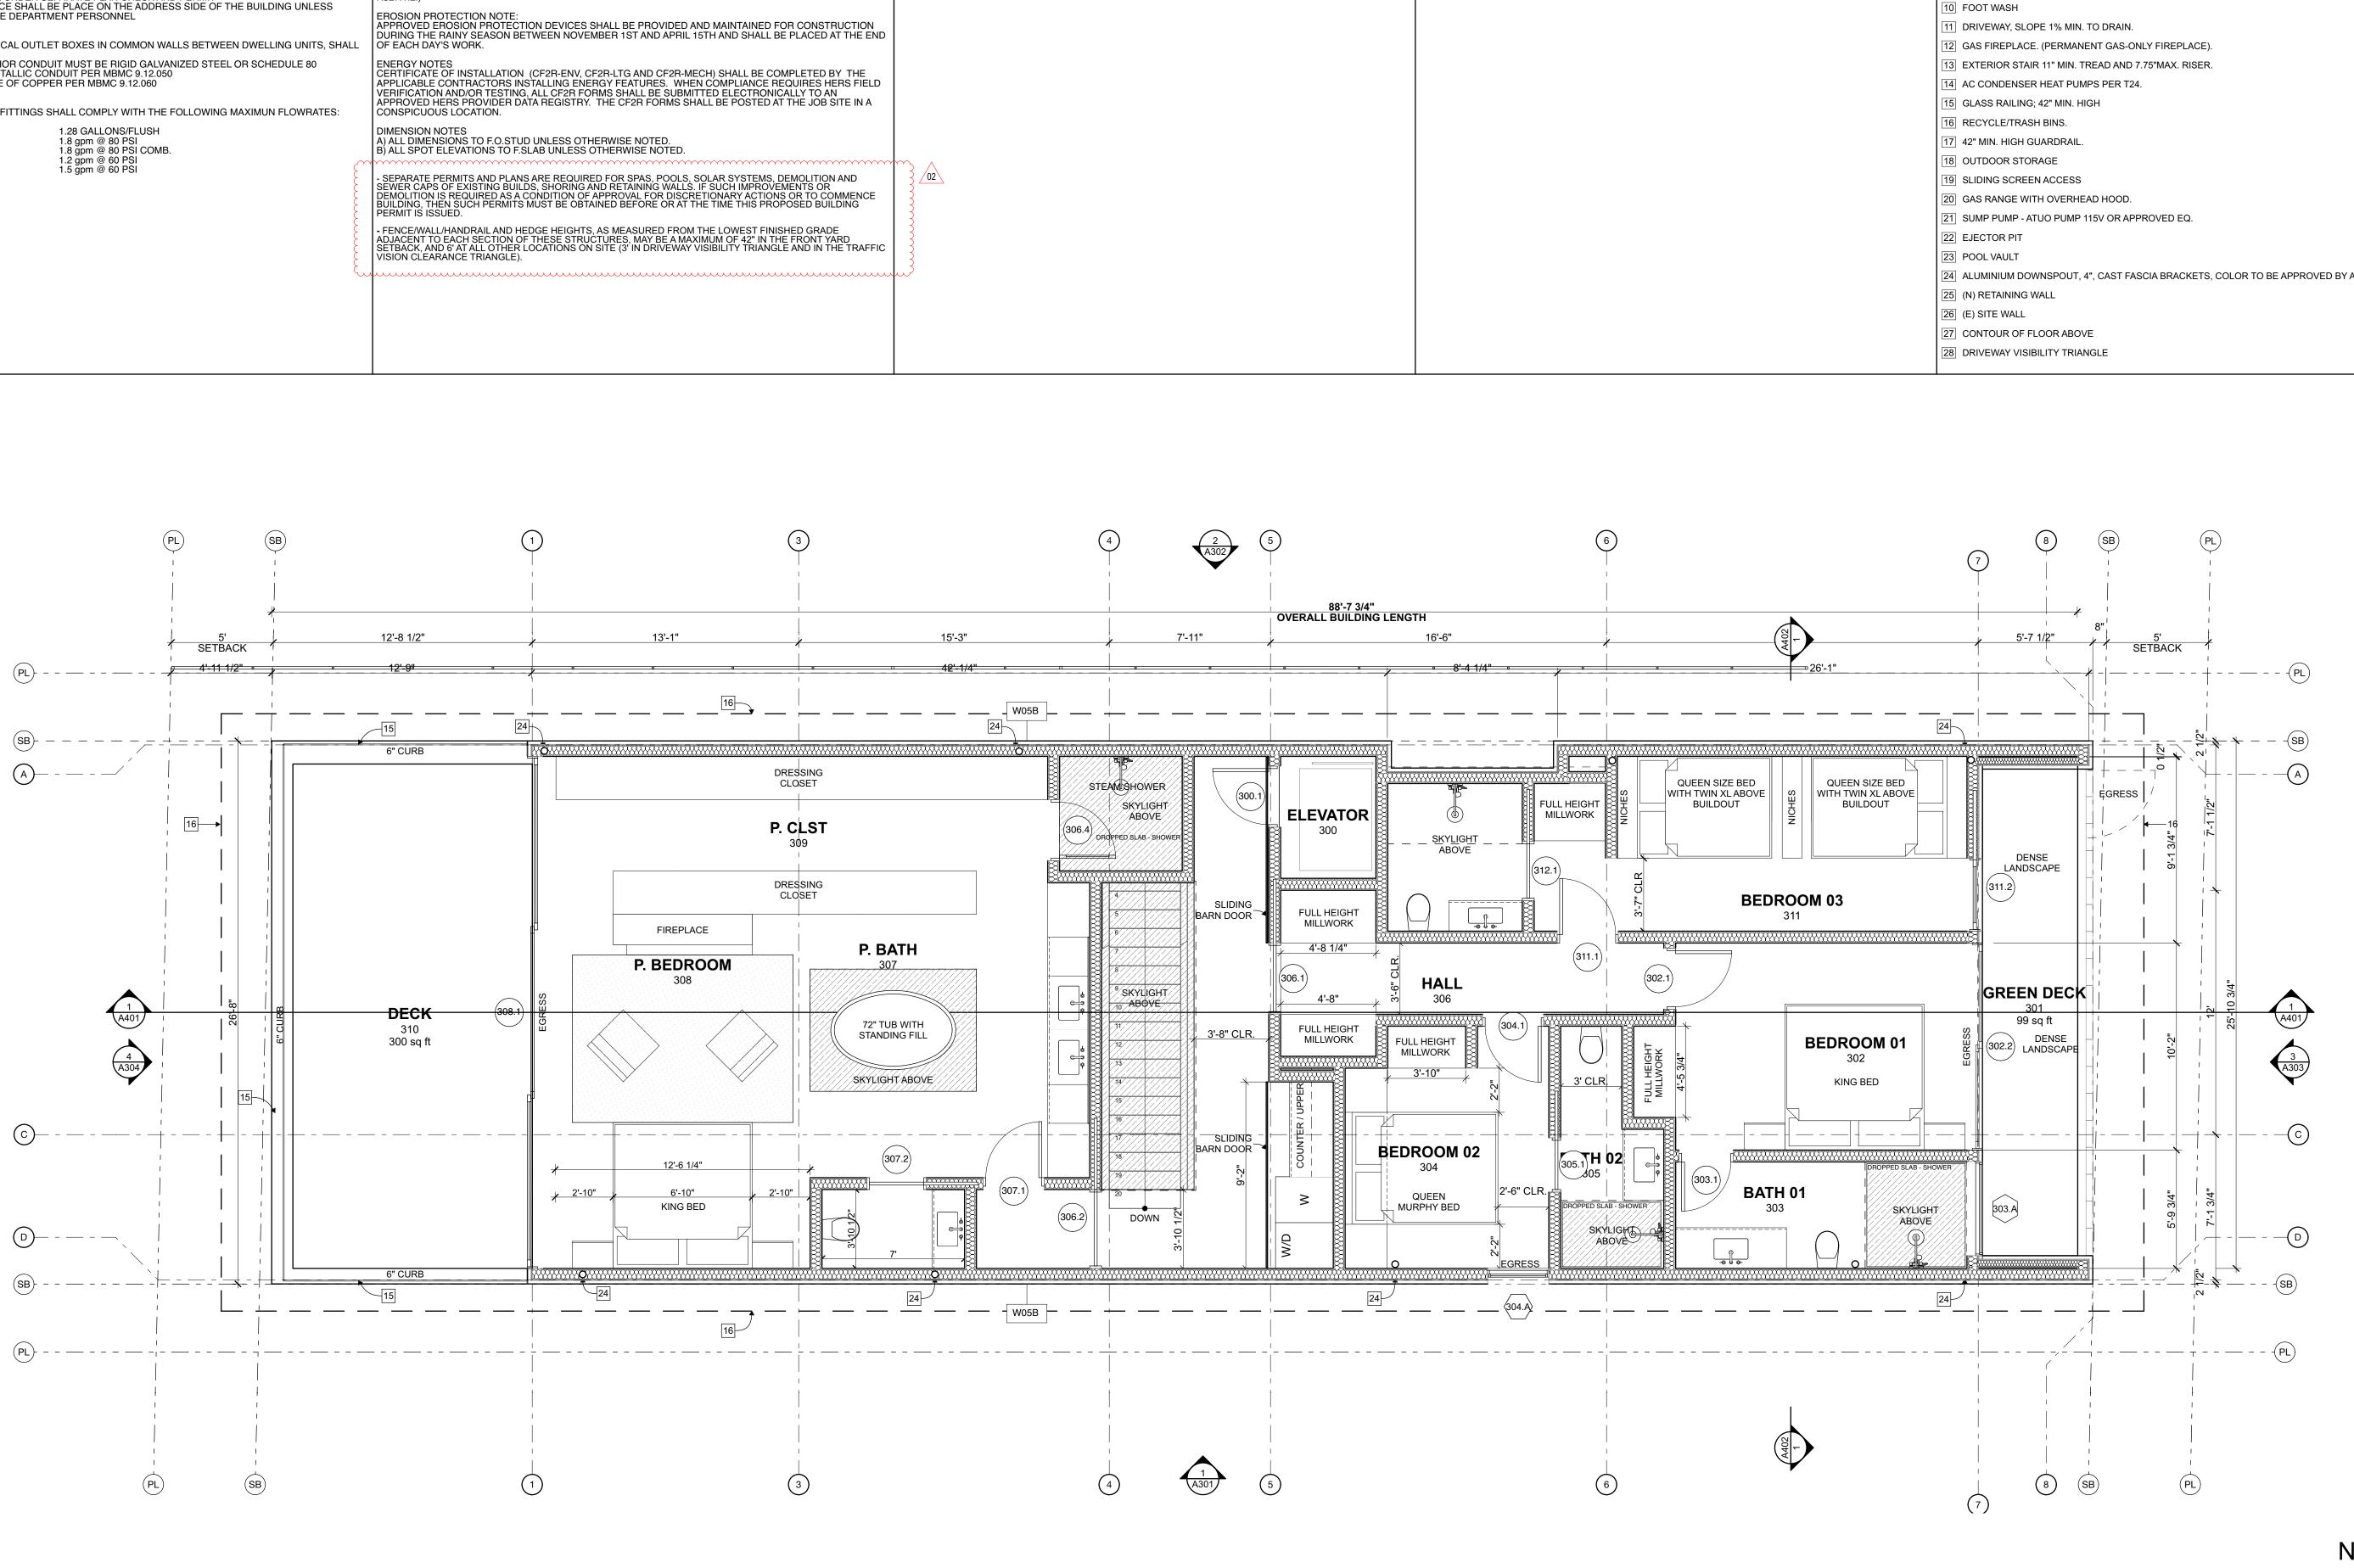
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F	PERMITS ISSUED.
ξ.	- FENCE/WALL/HANDRAIL AND HEDGE HEIGHTS, AS MEASURED FROM THE LOWEST FINISHED GRADE
۲	AD IACENT TO EACH SECTION OF THESE STRUCTURES MAY BE A MAXIMUM OF 42" IN THE FRONT YARD



3 3RD FLOOR PLAN SCALE: 1/4" = 1'-0"

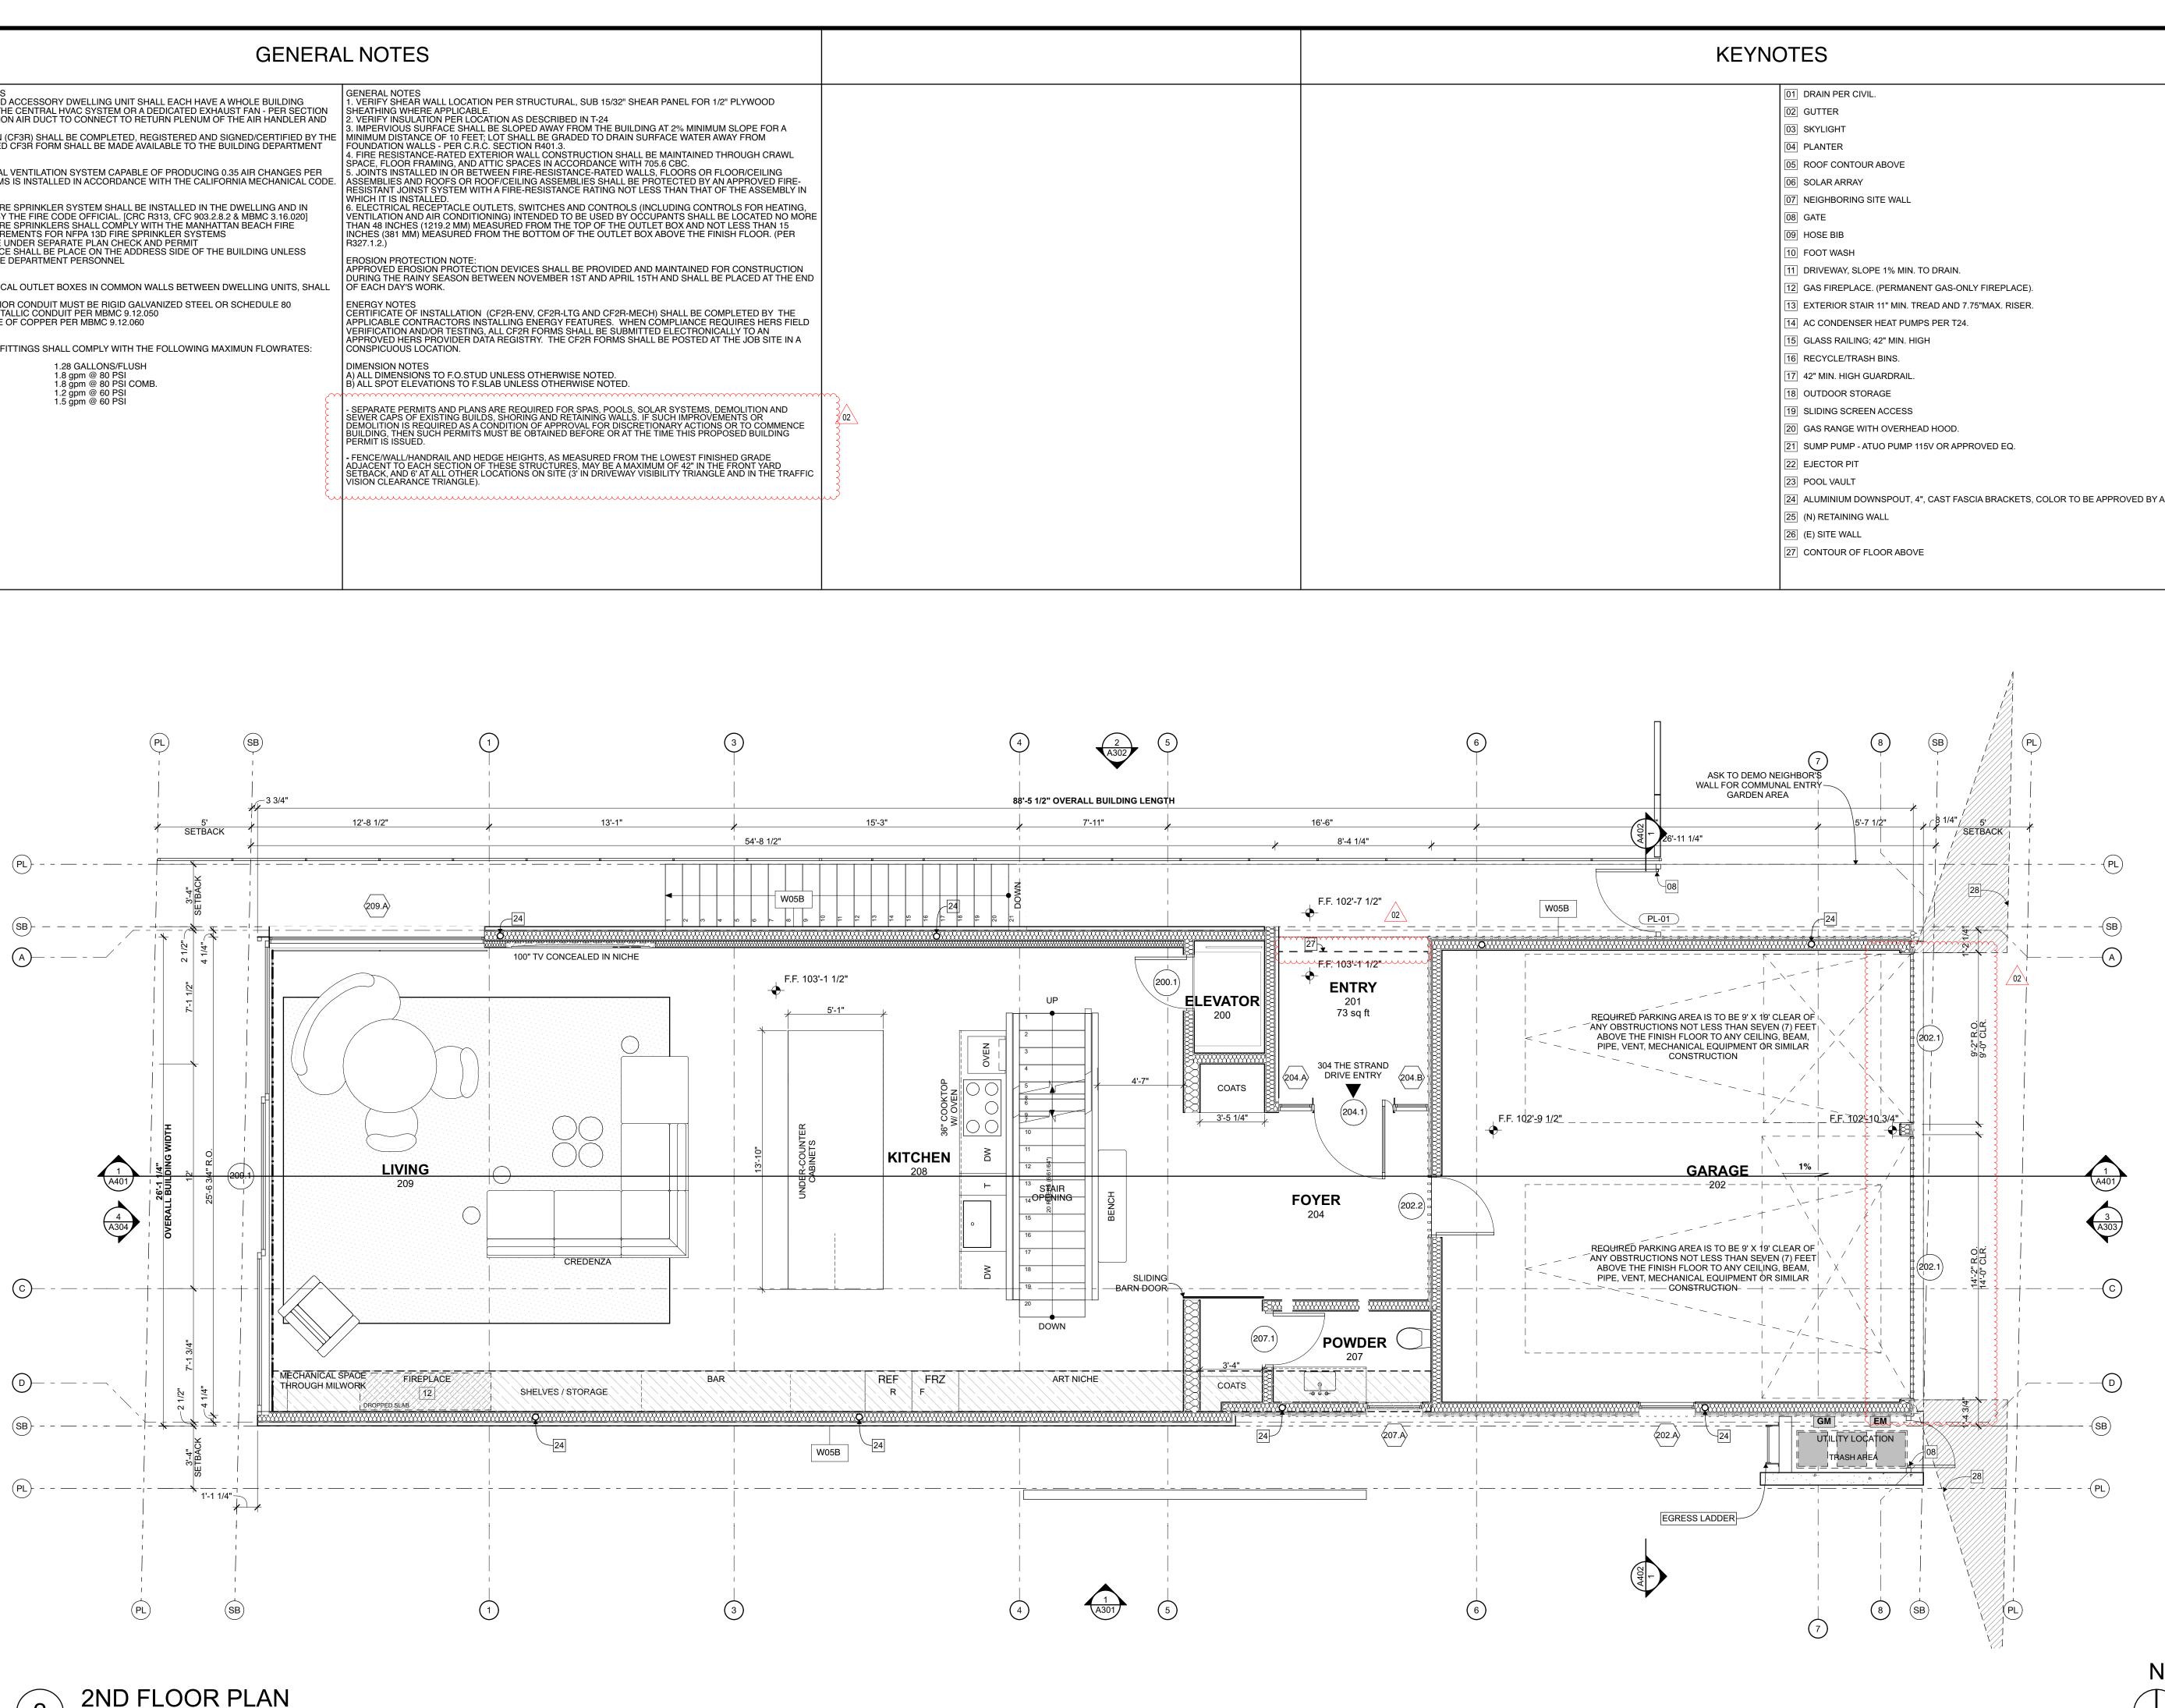OR HEATING, ATED NO MORE THAN 15 OOR. (PER

## KEYNOTES

- 01 DRAIN PER CIVIL. 02 GUTTER 03 SKYLIGHT 04 PLANTER 05 ROOF CONTOUR ABOVE 06 SOLAR ARRAY 07 NEIGHBORING SITE WALL 08 GATE 09 HOSE BIB 10 FOOT WASH

- 24 ALUMINIUM DOWNSPOUT, 4", CAST FASCIA BRACKETS, COLOR TO BE APPROVED BY ARCHITECT

0 2' 4'


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3RD FLOOR PLAN					

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## **GENERAL NOTES** GENERAL NOTES 1. VERIFY SHEAR WALL LOCATION PER STRUCTURAL, SUB 15/32" SHEAR PANEL FOR 1/2" PLYWOOD SHEATHING WHERE APPLICABLE. 2. VERIFY INSULATION PER LOCATION AS DESCRIBED IN T-24 3. IMPERVIOUS SURFACE SHALL BE SLOPED AWAY FROM THE BUILDING AT 2% MINIMUM SLOPE FOR A MINIMUM DISTANCE OF 10 FEET; LOT SHALL BE GRADED TO DRAIN SURFACE WATER AWAY FROM FOUNDATION WALLS - PER C.R.C. SECTION R401.3. 4. FIRE RESISTANCE-RATED EXTERIOR WALL CONSTRUCTION SHALL BE MAINTAINED THROUGH CRAWL SPACE, FLOOR FRAMING, AND ATTIC SPACES IN ACCORDANCE WITH 705.6 CBC. 5. JOINTS INSTALLED IN OR BETWEEN FIRE-RESISTANCE-RATED WALLS, FLOORS OR FLOOR/CEILING ASSEMBLIES AND ROOFS OR ROOF/CEILING ASSEMBLIES SHALL BE PROTECTED BY AN APPROVED FIRE-RESISTANT JOINST SYSTEM WITH A FIRE-RESISTANCE RATING NOT LESS THAN THAT OF THE ASSEMBLY IN WHICH IT IS INSTALLED. 6. ELECTRICAL RECEPTACLE OUTLETS, SWITCHES AND CONTROLS (INCLUDING CONTROLS FOR HEATING, VENTILATION AND AIR CONDITIONING) INTENDED TO BE USED BY OCCUPANTS SHALL BE LOCATED NO MORE THAN 48 INCHES (1219.2 MM) MEASURED FROM THE TOP OF THE OUTLET BOX AND NOT LESS THAN 15 INCHES (381 MM) MEASURED FROM THE BOTTOM OF THE OUTLET BOX ABOVE THE FINISH FLOOR. (PER R327.1.2.) LIGHT AND VENTILATION NOTES SINGLE FAMILY RESIDENCE AND ACCESSORY DWELLING UNIT SHALL EACH HAVE A WHOLE BUILDING VENTILATION SYSTEM USING THE CENTRAL HVAC SYSTEM OR A DEDICATED EXHAUST FAN - PER SECTION 150.0(O).DEDICATED VENTILATION AIR DUCT TO CONNECT TO RETURN PLENUM OF THE AIR HANDLER AND TO THE DWELLING EXTERIOR. CERTIFICATE OF VERIFICATION (CF3R) SHALL BE COMPLETED, REGISTERED AND SIGNED/CERTIFIED BY THE HERS RATER. THE REGISTERED CF3R FORM SHALL BE MADE AVAILABLE TO THE BUILDING DEPARTMENT AND BUILDER. PER CRC R303.1-1: MECHANICAL VENTILATION SYSTEM CAPABLE OF PRODUCING 0.35 AIR CHANGES PER HOUR IN THE HABITABLE ROOMS IS INSTALLED IN ACCORDANCE WITH THE CALIFORNIA MECHANICAL CODE. FIRE SAFETY NOTES: A) AUTOMATIC RESIDENTIAL FIRE SPRINKLER SYSTEM SHALL BE INSTALLED IN THE DWELLING AND IN OTHER AREAS AS REQUIRED BY THE FIRE CODE OFFICIAL. [CRC R313, CFC 903.2.8.2 & MBMC 3.16.020] B) AUTOMATIC RESIDENTIAL FIRE SPRINKLERS SHALL COMPLY WITH THE MANHATTAN BEACH FIRE DEPARTMENT MINIMUM REQUIREMENTS FOR NEPA 13D FIRE SPRINKLER SYSTEMS C) FIRE SPRINKLERS SHALL BE UNDER SERVICE AN OHEORY AND DEPANT C) FIRE SPRINKLERS SHALL BE UNDER SEPARATE PLAN CHECK AND PERMIT D) HORN/STROBE ALARM DEVICE SHALL BE PLACE ON THE ADDRESS SIDE OF THE BUILDING UNLESS OTHERWISE SPECIFIED BY FIRE DEPARTMENT PERSONNEL R327.1.2.) EROSION PROTECTION NOTE: APPROVED EROSION PROTECTION DEVICES SHALL BE PROVIDED AND MAINTAINED FOR CONSTRUCTION DURING THE RAINY SEASON BETWEEN NOVEMBER 1ST AND APRIL 15TH AND SHALL BE PLACED AT THE END ELECTRICAL NOTES: A) PENETRATIONS OF ELECTRICAL OUTLET BOXES IN COMMON WALLS BETWEEN DWELLING UNITS, SHALL BE PROTECTED. (CRC R302.4) B) ALL ABOVE-GROUND EXTERIOR CONDUIT MUST BE RIGID GALVANIZED STEEL OR SCHEDULE 80 SUNLIGHT-RESISTANT NON METALLIC CONDUIT PER MBMC 9.12.050 OF EACH DAY'S WORK. ENERGY NOTES CERTIFICATE OF INSTALLATION (CF2R-ENV, CF2R-LTG AND CF2R-MECH) SHALL BE COMPLETED BY THE APPLICABLE CONTRACTORS INSTALLING ENERGY FEATURES. WHEN COMPLIANCE REQUIRES HERS FIELD VERIFICATION AND/OR TESTING, ALL CF2R FORMS SHALL BE SUBMITTED ELECTRONICALLY TO AN APPROVED HERS PROVIDER DATA REGISTRY. THE CF2R FORMS SHALL BE POSTED AT THE JOB SITE IN A C) ALL CONDUCTORS SHALL BE OF COPPER PER MBMC 9.12.060 PLUMBING NOTES:ALL PLUMBING FIXTURES AND FITTINGS SHALL COMPLY WITH THE FOLLOWING MAXIMUN FLOWRATES:(CGBSC 4.303.1)A) WATER CLOSETS1.28 GALLONS/FLUSHB) SHOWERHEADS-SINGLE1.8 gpm @ 80 PSIC) SHOWERHEADS-MULT.1.8 gpm @ 80 PSI COMB.D) LAVATORY FAUCETS1.2 gpm @ 60 PSIE) KITCHEN FAUCETS1.5 gpm @ 60 PSI CONSPICUOUS LOCATION. DIMENSION NOTES A) ALL DIMENSIONS TO F.O.STUD UNLESS OTHERWISE NOTED. B) ALL SPOT ELEVATIONS TO F.SLAB UNLESS OTHERWISE NOTED.




**ROOF PLAN** 



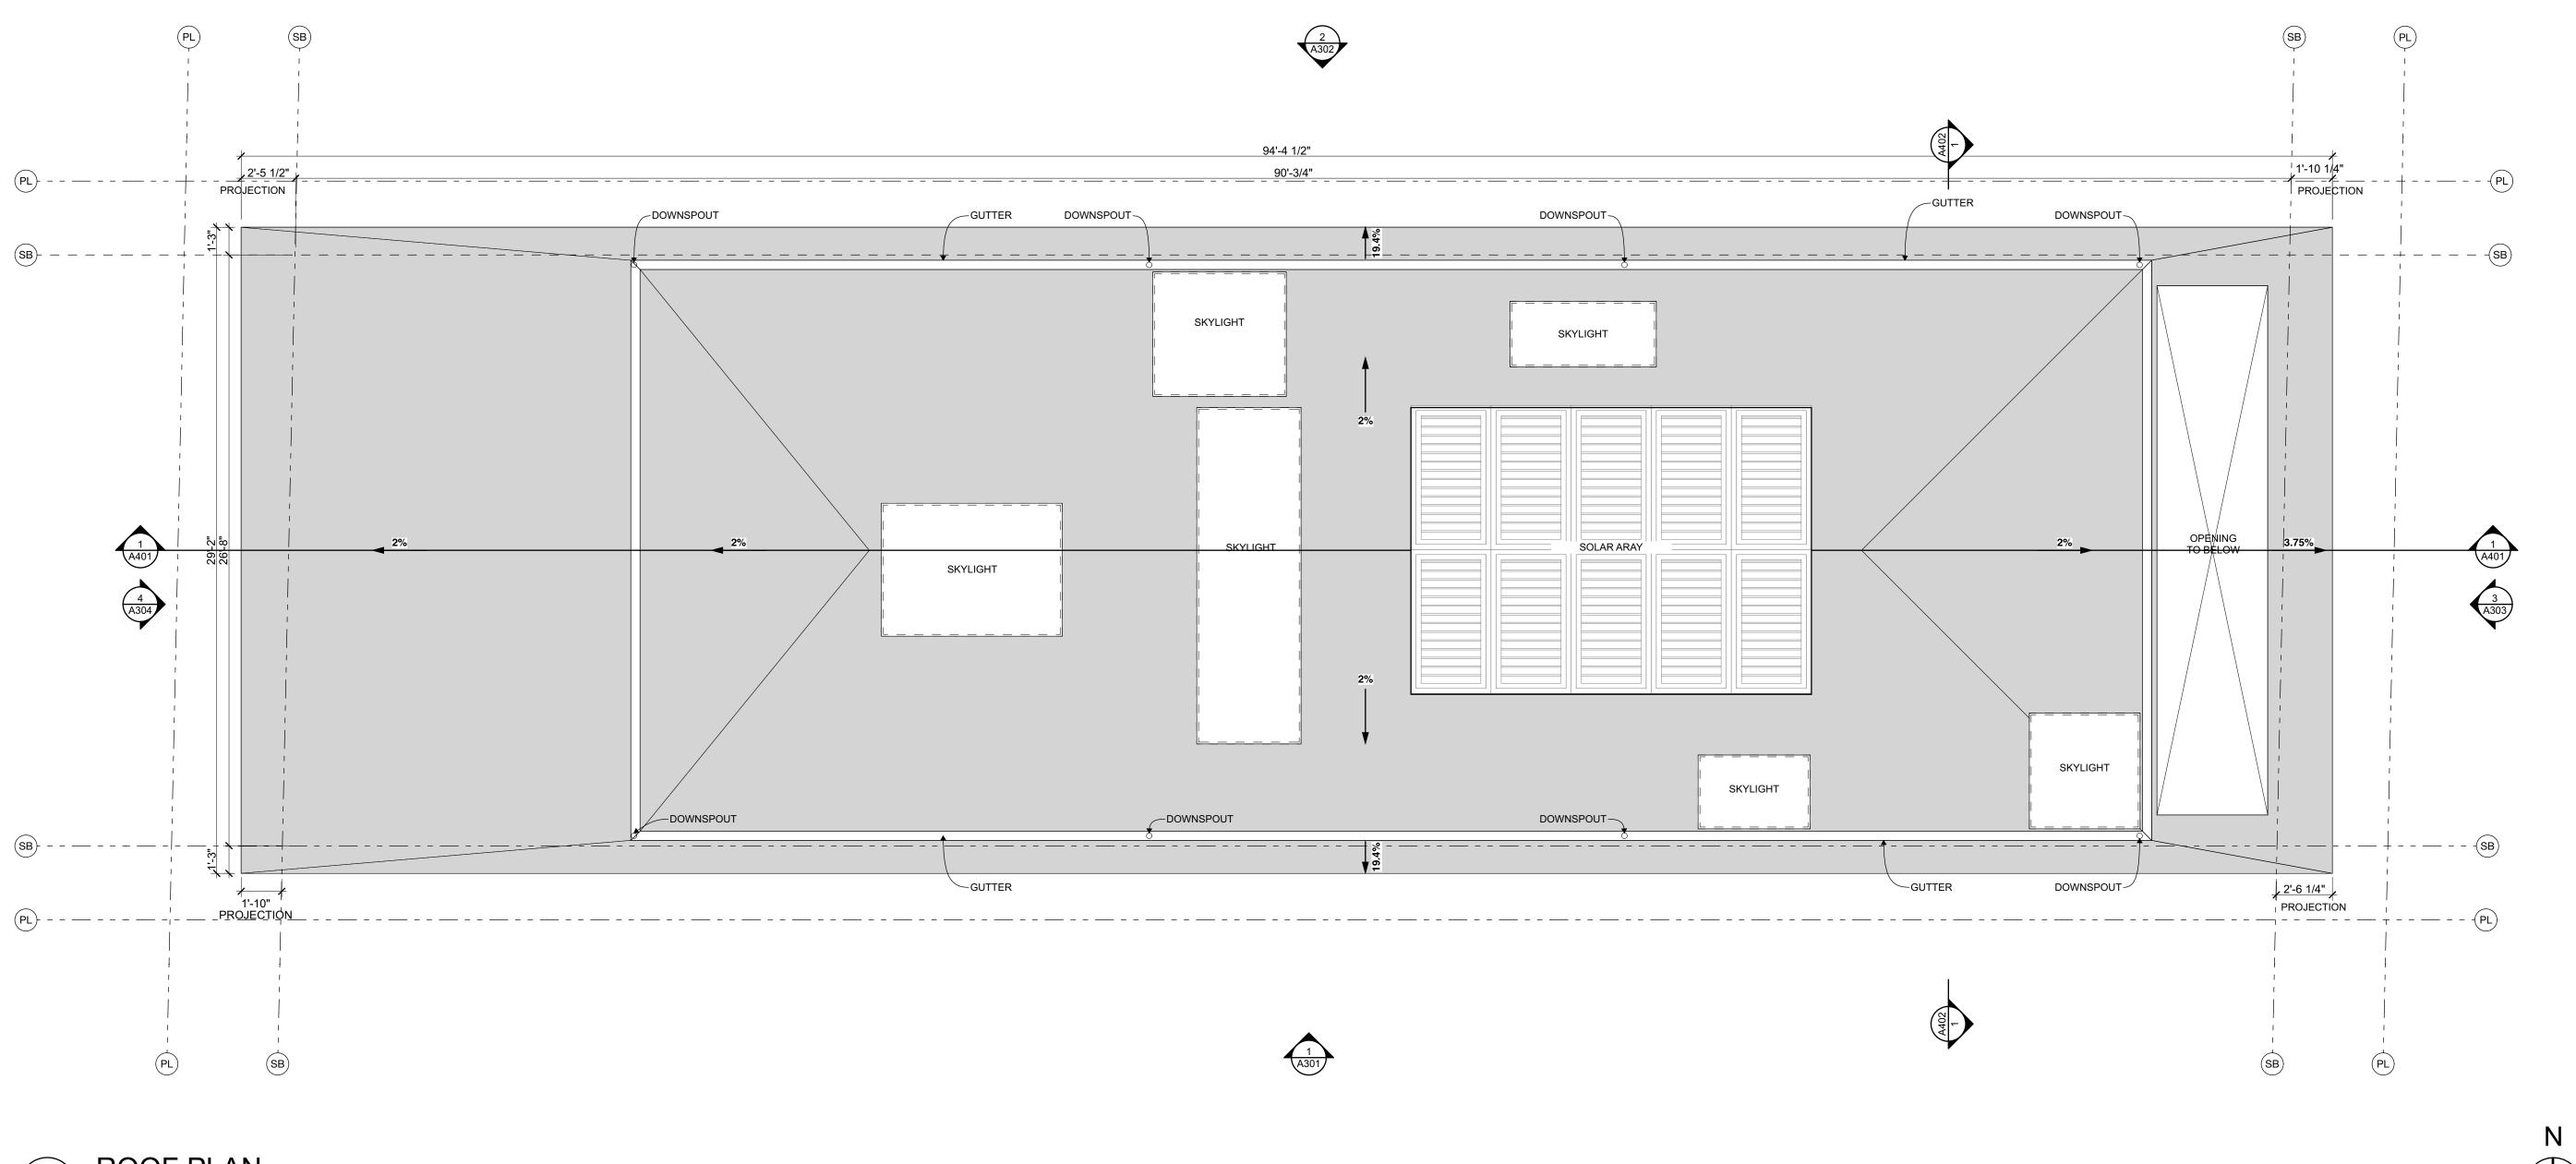


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- [13] EXTERIOR STAIR 11" MIN. TREAD AND 7.75"MAX. RISER.
- 14 AC CONDENSER HEAT PUMPS PER T24.
- [15] GLASS RAILING; 42" MIN. HIGH
- 16 RECYCLE/TRASH BINS.
- 17 42" MIN. HIGH GUARDRAIL
- 18 OUTDOOR STORAGE
- 19 SLIDING SCREEN ACCESS
- [20] GAS RANGE WITH OVERHEAD HOOD.
- 21 SUMP PUMP ATUO PUMP 115V OR APPROVED EQ.
- 22 EJECTOR PIT
- 23 POOL VAULT
- 24 ALUMINIUM DOWNSPOUT, 4", CAST FASCIA BRACKETS, COLOR TO BE APPROVED BY ARCHITECT
- 25 (N) RETAINING WALL
- [26] (E) SITE WALL
- 27 CONTOUR OF FLOOR ABOVE 28 DRIVEWAY VISIBILITY TRIANGLE

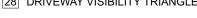

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- W) PROVIDE UNDERGROUND ELECTRICAL AND COMMUNICATION SERVICE LATERALS PER CITY **ORDINANCE SECTION 9.12.050**
- ) PARAPETS, SATELLITE ANTENNA, RAILS, SKYLIGHTS, ROOF EQUIPMENT MUST BE WITHIN THE HEIGHT LIMIT
- /) SOLAR PANELS: NEW HOUSE SHALL HAVE A SPARE RACEWAY FOR FUTURE SOLAR PANELS PER SOLAR CODE.
   // SOLAR CODE.
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  - L) EXTERIOR PAVING: IMPERVIOUS SURFACE SHALL BE SLOPED AWAY FROM THE BUILDING AT 2% MINIMUM SLOPE FOR A MINIMUM DISTANCE OF 10 FEE. LOT SHALL BE GRADED TO DRAIN SURFACE WATER AWAY FROM FOUNDATION WALLS PER CRC SECTION R401.3. ALL EXTERIOR PAVING SHALL BE SLOPED TO EITHER AREA DRAINS, THE STREET, OR ADJACENT PLANTING AREAS, DEPENDING ON THE LOCATION AND CONDITION. REFER TO CIVIL DRAWINGS FOR MORE INFORMATION.
  - M) PAVING JOINTS: CONTRACTOR TO VERIFY FINISH OF PAVING JOINTS FOR ALL EXTERIOR PAVING PRIOR TO PERFORMING ANY WORK.
  - N) CONTROL JOINTS: CONTRACTOR TO VERIFY QUANTITY AND LOCATIONS OF CONTROL JOINTS FOR ALL EXTERIOR PAVING PRIOR TO PERFORMING ANY WORK. O) SITE WALLS: CONTRACTOR TO VERIFY THAT ALL NEW YARD WALLS COMPLY WITH ZONING CODE HEIGHT LIMITATIONS. P) EXTERIOR WALLS: ALL EXTERIOR WALLS LOCATED WITHIN 5' OF PROPERTY LINES SHALL BE ONE-
  - HOUR FIRE RATED PER CRC TABLE R302.1 (
  - **Q) FENCE/WALL/HANDRAIL/HEDGE HEIGHTS:** CONTRACTOR TO MEET ALL STATE AND LOCAL CODE REQUIREMENTS FOR SUCH STRUCTURES. REFER TO SITE PLAN FOR DRIVEWAY VISIBILITY REQUIREMENTS. HEIHTS TO BE MEASURED FROM THE LOWEST FINISHED ADJACENT GRADE.
  - R) CURB CUTS AND SIDEWALKS: CONTRACTOR IS REQUIRED TO OBTAIN A SEPARATE PERMIT FOR ALL CURB CUTS AND SIDEWALK CONSTRUCTION. CONSTRUCT ALL NEW CURBS AND SIDEWALKS PER APPROVED CITY ENGINEERING OR PUBLIC WORKS DEPARTMENT REQUIREMENTS. S) LANDSCAPE COORDINATION: CONTRACTOR TO PROVIDE AND COORDINATE ALL WATER SUPPLY'S AND POWER REQUIREMENTS FOR LANDSCAPE IRRIGATION SYSTEM.
  - T) DRIVEWAY PROFILES: DRIVEWAY PROFILES EXCEEDING 10% GRADE SHALL BE STAKED AND VERIFIED BY LICENSED PROFESSIONAL LAND SURVEYOR PRIOR TO POURING THE GARAGE SLAB. DRIVEWAY GRADES EXCEEDING 15% ARE NOT PERMITTED.
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SOUTH ELEVATION 1

3/12/24 4:23 PM

- A) SETBACKS: CONTRACTOR SHALL VERIFY THAT ALL CODE REQUIRED SETBACKS AND HEIGHT 23 POOL VAULT LIMITATIONS ARE OBSERVED. REFER TO ZONING DIAGRAMS FOR MORE INFORMATION. B) EXCAVATIONS, BACKFILL, AND COMPACTION REQUIREMENTS: CONTRACTOR SHALL COMPLY WITH ALL REQUIREMENTS OF THE GEOTECHNICAL ENGINEERING REPORT, SOILS REPORT AND/OR SHORING ENGINEERING, FOR ALL EXCAVATIONS, BACKFILL, AND COMPACTION C) SHORING: IF REQUIRED, SHORING IS TO BE UNDER SEPARATE PERMIT PREPARED BY STRUCTURAL
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- E) PROTECTION OF EXISTING STRUCTURES: ALL EXISTING STRUCTURES NOT INDICATED TO BE REMOVED SHALL BE PROTECTED DURING DEMOLITION AND CONSTRUCTION. ANY FINISHES THAT ARE REMOVED OR OTHERWISE DAMAGED SHALL BE REPLACED BY THE CONTRACTOR AT NO COST TO THE OWNER.
- ) STORM DRAINAGE/SUSMP REQUIREMENTS: CONTRACTOR SHALL VERIFY WITH GOVERNING AGENCIES IF A STANDARD URBAN STORMWATER MITIGATION PLAN (SUSMP) OR OTHER POLLUTION PREVENTION FILTERING SYSTEM IS REQUIRED. ALL DOWNSPOUTS AND AREA DRAINS SHALL CONNECT INTO PVC DRAINAGE PIPES THAT TERMINATE AT THE SUSMP OR TO THE STREET AS REQUIRED.
- G) SEWER CLEAN-OUTS: CONTRACTOR TO COORDINATE LOCATION OF ALL SEWER CLEAN-OUTS WITH ARCHITECT PRIOR TO PERFORMING ANY WORK. UTILITIES: CONTRACTOR SHALL COORDINATE LOCATION OF ALL NEW UTILITY CONNECTION POINTS
- AND METERS. CONTRACTOR SHALL PROTECT ALL EXISTING UTILITY SUPPLIES, CONNECTION POINTS AND METERS FROM DAMAGE. **UNDERGROUND UTILITIES:** ELECTRICAL, TELEPHONE, CABLE TELEVISION SYSTEMS AND SIMILAR SERVICE QIRES AND CABLES SHALL BE INSTALLED UNDERGROUND IN COMPLIANCE WITH APPLICABLE BUILDING AND ELECTRICAL CODES, SAFETY REGULATIONS AND ORDERS, RULES OF THE PUBLIC UTILITIES COMMISSION OF THE STATE OF CALIFORNIA AND SPECIFICATIONS OR STANDARDS OF THE PUBLIC WORKS DEPARTMENTS.
- **TRENCHING:** TRENCH SEPARATION REQUIREMENTS SHALL BE IN ACCORDANCE WITH CALIFORNIA DEPARTMENT OF HEALTH SERVICES "CRITERIA FOR SEPARATION OF WATER MAINS AND NON-POTABLE PIPELINES."

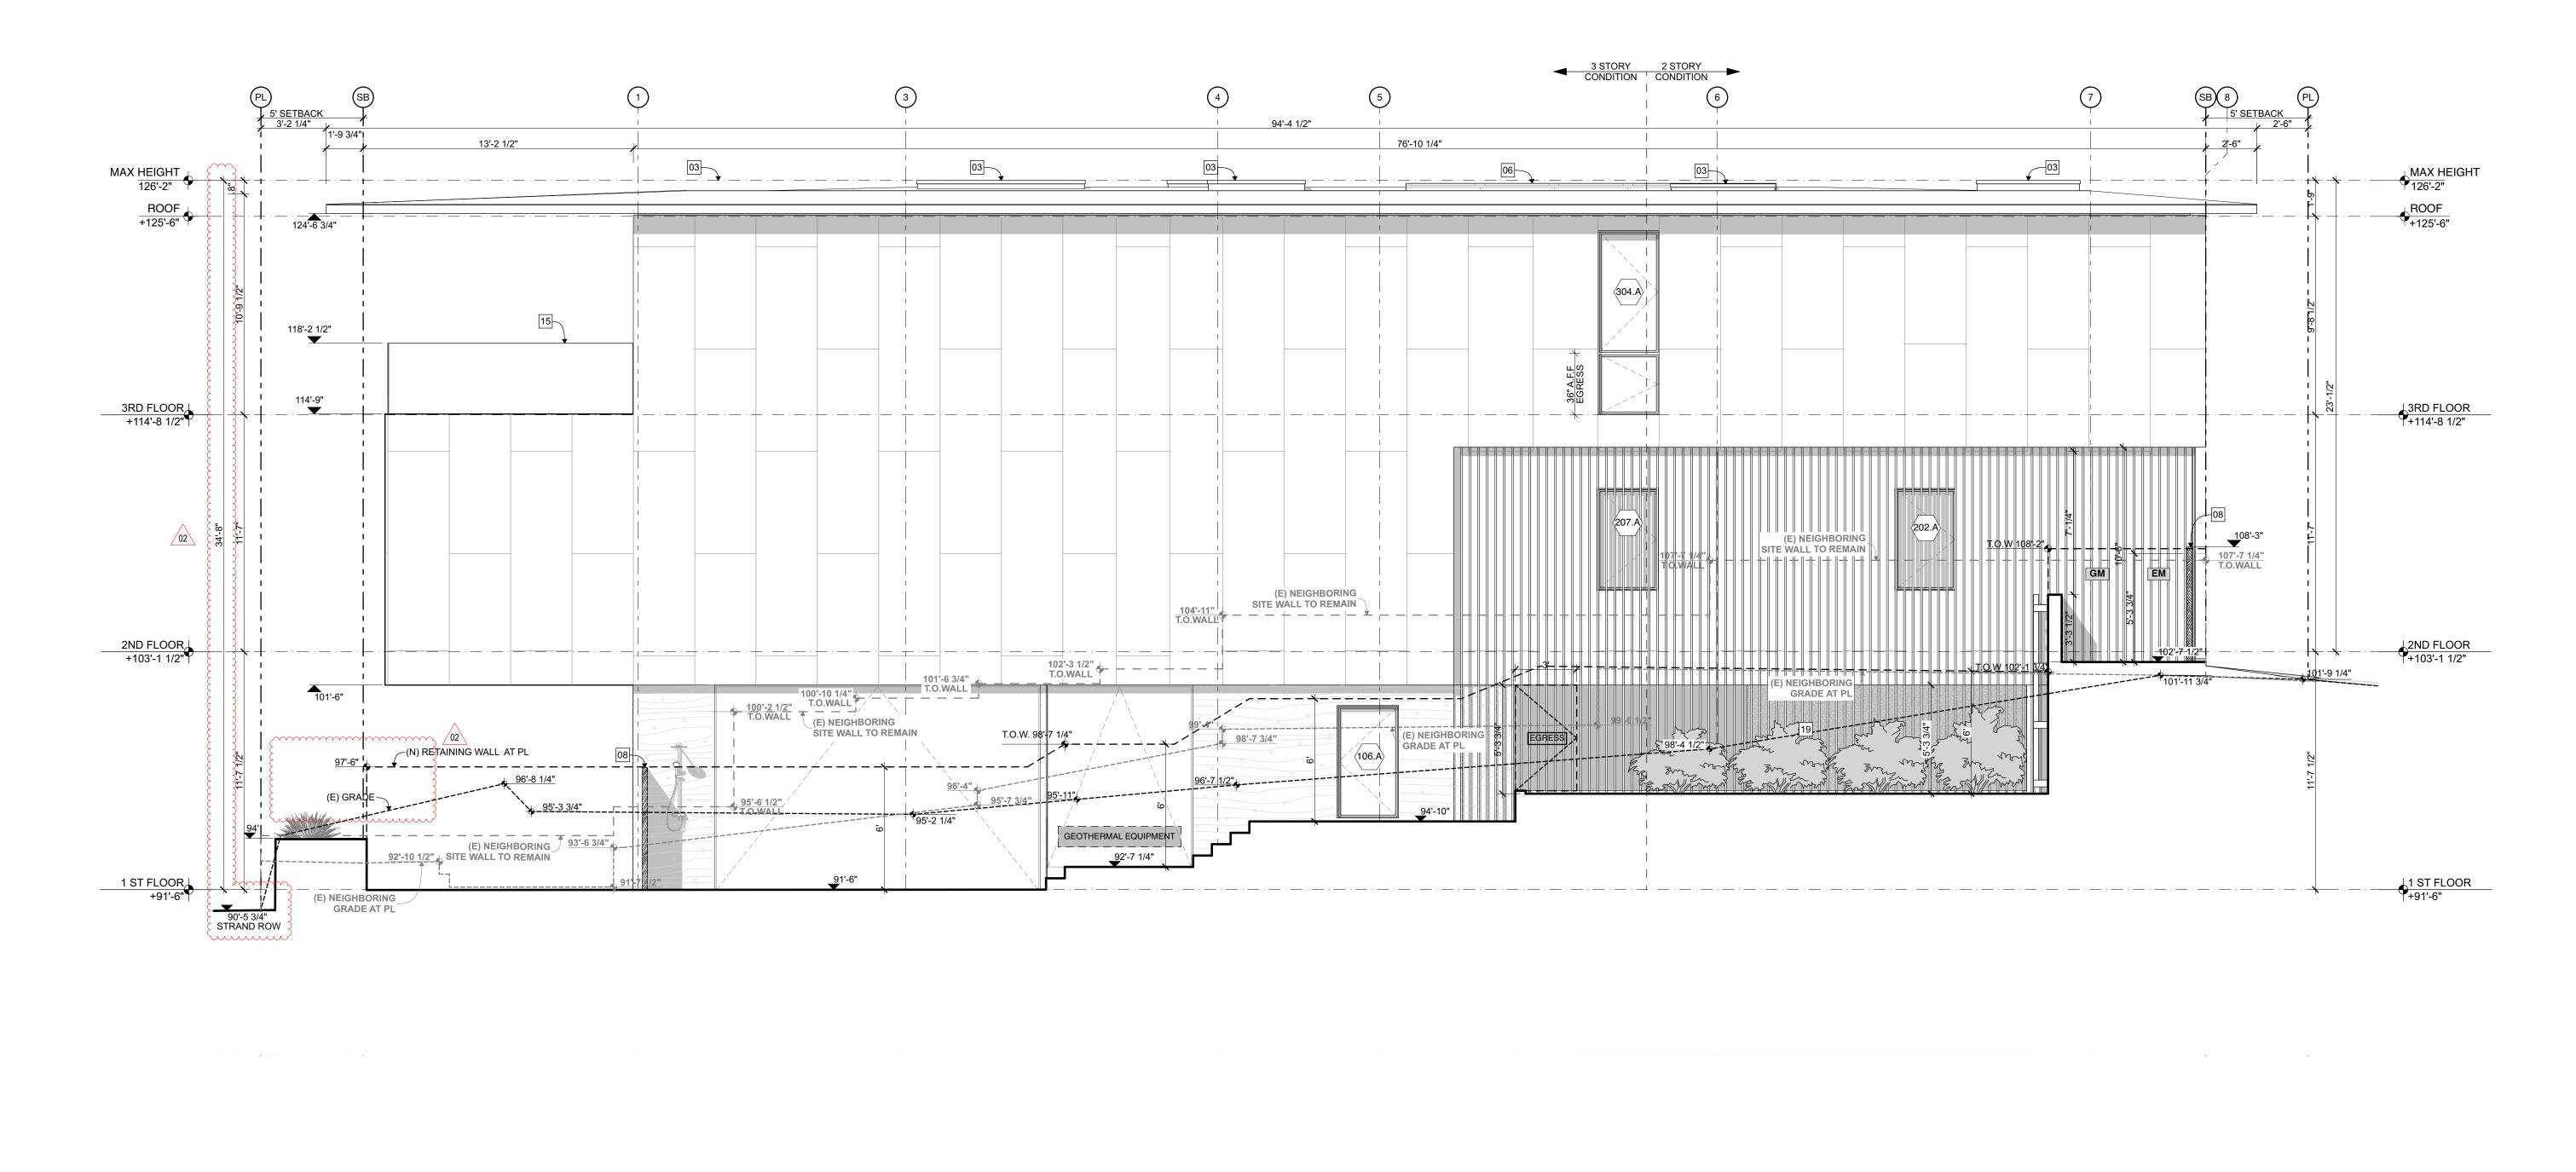- ALUMINIUM DOWNSPOUT, 4", CAST FASCIA BRACKETS, COLOR TO BE APPROVED BY ARCHITECT 5 (N) RETAINING WALL
- 26 (E) SITE WALL
- 7 CONTOUR OF FLOOR ABOVE

## **KEYNOTES**

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PROJECT NAME 304 The Strand - Maxwell PROJECT NUMBEF

CLIENT SCOTT MAXWELL

23003

PROJECT ADDRESS 304 The Strand Manhattan Beach, CA 90266

#### ARCHITECT ANTHONY LANEY AIA LANEY LA, INC. 725 CYPRESS AVE HERMOSA BEACH CA 90254 (310) 870-7175 ÀNTHONY@LANEY.LA



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1	11/14/23	CDP	
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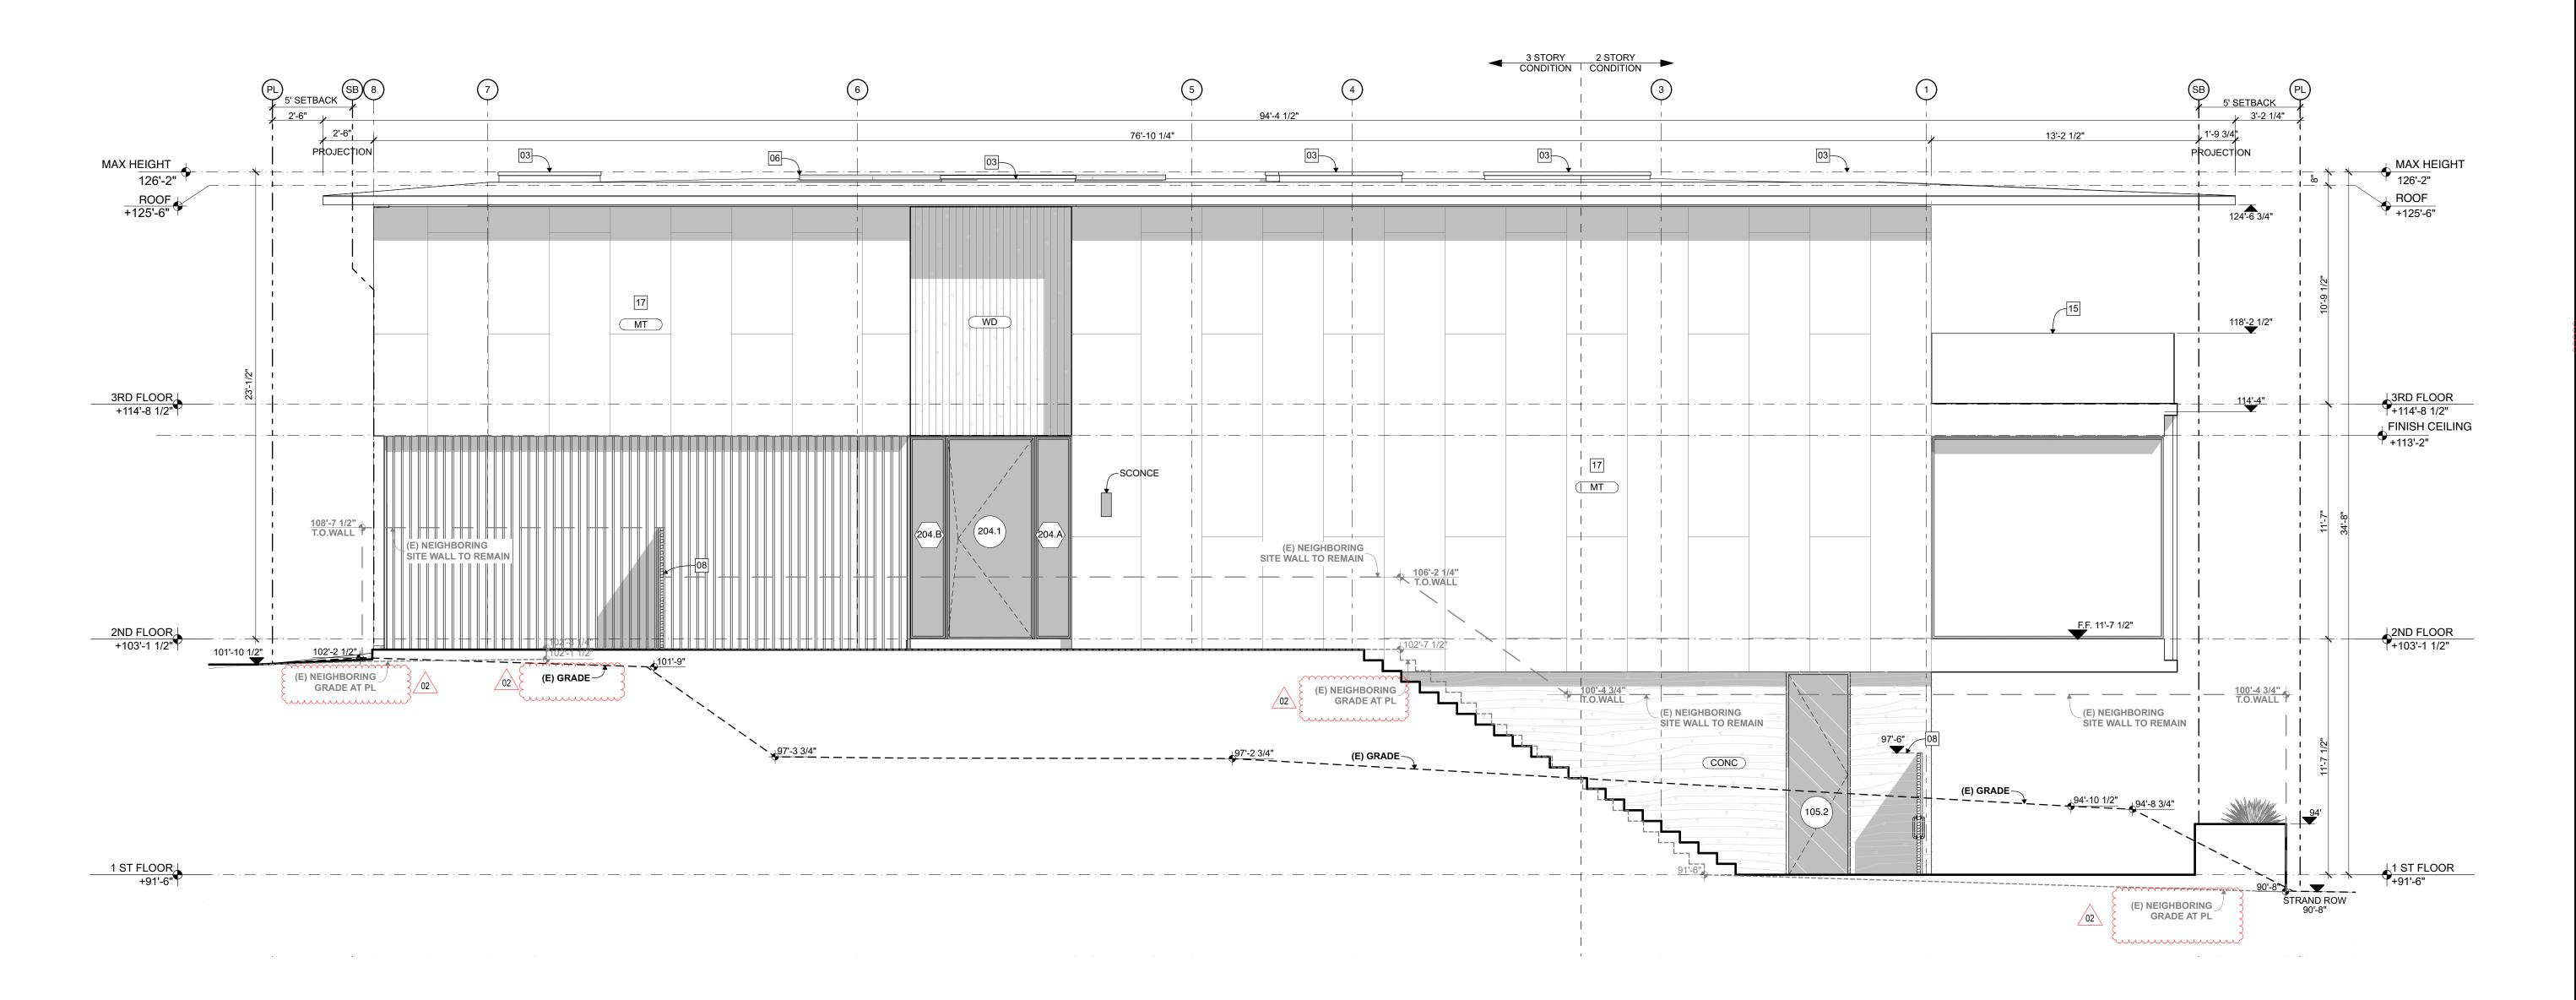
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SOUTH ELEVATION

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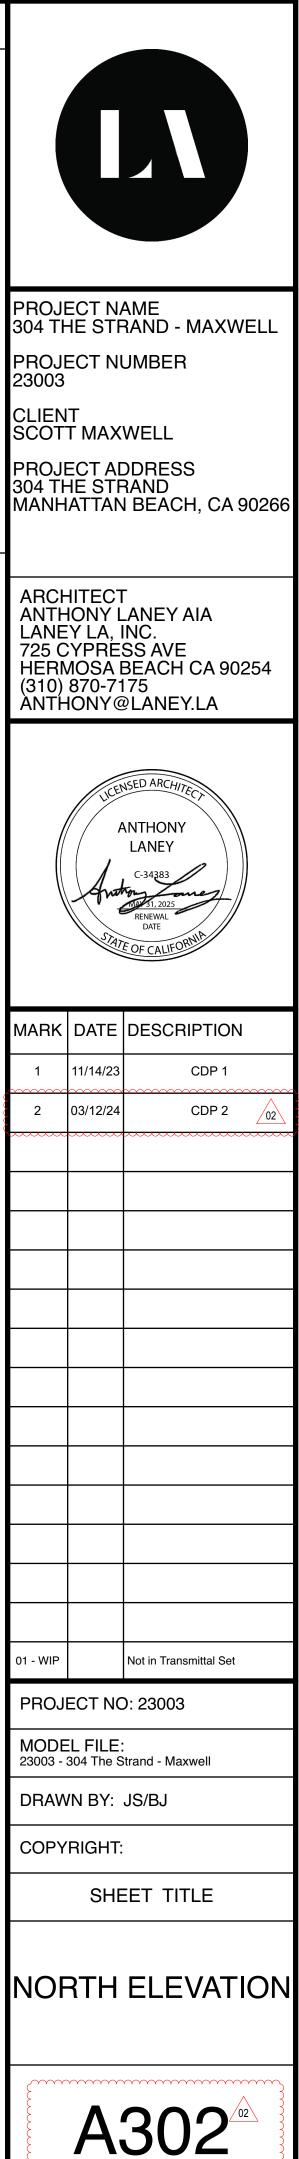
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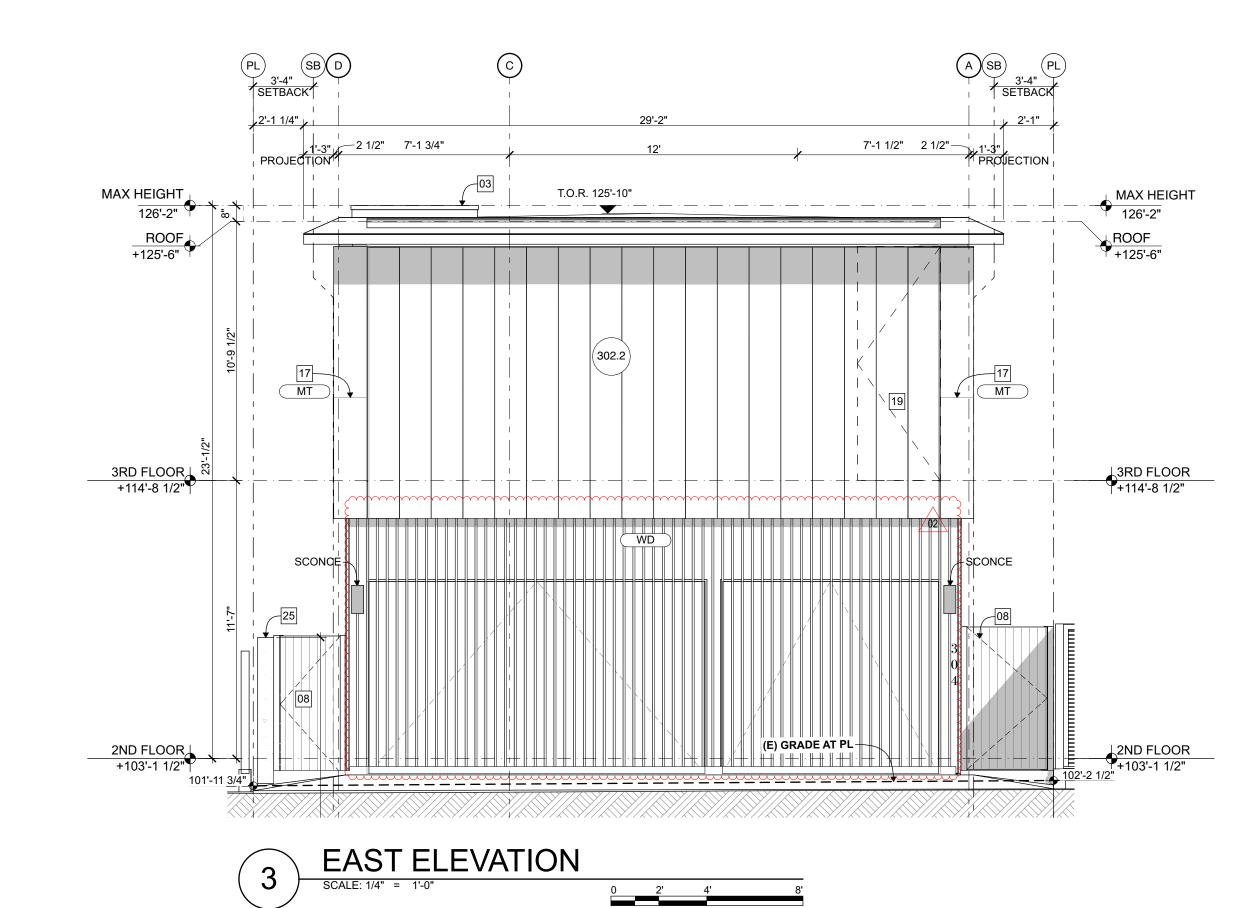
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22 EJECTOR PIT



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  - R) CURB CUTS AND SIDEWALKS: CONTRACTOR IS REQUIRED TO OBTAIN A SEPARATE PERMIT FOR ALL CURB CUTS AND SIDEWALK CONSTRUCTION. CONSTRUCT ALL NEW CURBS AND SIDEWALKS PER APPROVED CITY ENGINEERING OR PUBLIC WORKS DEPARTMENT REQUIREMENTS.
  - S) LANDSCAPE COORDINATION: CONTRACTOR TO PROVIDE AND COORDINATE ALL WATER SUPPLY'S AND POWER REQUIREMENTS FOR LANDSCAPE IRRIGATION SYSTEM.
  - T) DRIVEWAY PROFILES: DRIVEWAY PROFILES EXCEEDING 10% GRADE SHALL BE STAKED AND VERIFIED BY LICENSED PROFESSIONAL LAND SURVEYOR PRIOR TO POURING THE GARAGE SLAB. DRIVEWAY GRADES EXCEEDING 15% ARE NOT PERMITTED. I) BUILDING ADDRESS: BUILDING ADDRESS SHALL BE PROVIDED ON THE BUILDING IN SUCH A POSITION AS TO BE PLAINLY VISIBLE AND LEGIBLE FROM THE STREET. ADDRESS NUMBERS SHALL
  - CONTRAST WITH THEIR BACKGROUND, 4" HIGH MINIMUM AND WITH A MINIMUM STROKE WIDTH OF 0.5" - PER SECTION R319.1



- A) SETBACKS: CONTRACTOR SHALL VERIFY THAT ALL CODE REQUIRED SETBACKS AND HEIGHT LIMITATIONS ARE OBSERVED. REFER TO ZONING DIAGRAMS FOR MORE INFORMATION. B) EXCAVATIONS, BACKFILL, AND COMPACTION REQUIREMENTS: CONTRACTOR SHALL COMPLY WITH ALL REQUIREMENTS OF THE GEOTECHNICAL ENGINEERING REPORT, SOILS REPORT AND/OR SHORING ENGINEERING, FOR ALL EXCAVATIONS, BACKFILL, AND COMPACTION C) SHORING: IF REQUIRED, SHORING IS TO BE UNDER SEPARATE PERMIT PREPARED BY STRUCTURAL
- ENGINEER PRIOR TO CONSTRUCTION. ) PROTECTION OF EXISTING PLANTING AND TRESS: ALL EXISTING PLANT MATERIAL AND TREES NOT 28 DRIVEWAY VISIBILITY TRIANGLE INDICATED TO BE REMOVED SHALL BE PROTECTED TO THE DRIP-LINE DURING DEMOLITION AND CONSTRUCTION. ANY PLANTING OR TREES THAT ARE DAMAGED OR KILLED SHALL BE REPLACED BY THE CONTRACTOR AT NO COST TO THE OWNER.
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- STORM DRAINAGE/SUSMP REQUIREMENTS: CONTRACTOR SHALL VERIFY WITH GOVERNING AGENCIES IF A STANDARD URBAN STORMWATER MITIGATION PLAN (SUSMP) OR OTHER POLLUTION PREVENTION FILTERING SYSTEM IS REQUIRED. ALL DOWNSPOUTS AND AREA DRAINS SHALL CONNECT INTO PVC DRAINAGE PIPES THAT TERMINATE AT THE SUSMP OR TO THE STREET AS REQUIRED.
- G) SEWER CLEAN-OUTS: CONTRACTOR TO COORDINATE LOCATION OF ALL SEWER CLEAN-OUTS WITH ARCHITECT PRIOR TO PERFORMING ANY WORK.
- I) UTILITIES: CONTRACTOR SHALL COORDINATE LOCATION OF ALL NEW UTILITY CONNECTION POINTS AND METERS. CONTRACTOR SHALL PROTECT ALL EXISTING UTILITY SUPPLIES, CONNECTION POINTS AND METERS FROM DAMAGE.
- **UNDERGROUND UTILITIES:** ELECTRICAL, TELEPHONE, CABLE TELEVISION SYSTEMS AND SIMILAR SERVICE QIRES AND CABLES SHALL BE INSTALLED UNDERGROUND IN COMPLIANCE WITH APPLICABLE BUILDING AND ELECTRICAL CODES, SAFETY REGULATIONS AND ORDERS, RULES OF THE PUBLIC UTILITIES COMMISSION OF THE STATE OF CALIFORNIA AND SPECIFICATIONS OR STANDARDS OF THE PUBLIC WORKS DEPARTMENTS.
- **TRENCHING:** TRENCH SEPARATION REQUIREMENTS SHALL BE IN ACCORDANCE WITH CALIFORNIA DEPARTMENT OF HEALTH SERVICES "CRITERIA FOR SEPARATION OF WATER MAINS AND NON-POTABLE PIPELINES."

- 23 POOL VAULT
- ALUMINIUM DOWNSPOUT, 4", CAST FASCIA BRACKETS, COLOR TO BE APPROVED BY ARCHITECT 5 (N) RETAINING WALL
- 26 (E) SITE WALL
- CONTOUR OF FLOOR ABOVE

## **KEYNOTES**

- 01 DRAIN PER CIVIL. 02 GUTTER 03 SKYLIGHT
- 04 PLANTER
- 05 ROOF CONTOUR ABOVE 06 SOLAR ARRAY
- 07 NEIGHBORING SITE WALL
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- 19 SLIDING SCREEN ACCESS
- [20] GAS RANGE WITH OVERHEAD HOOD.
- 21 SUMP PUMP ATUO PUMP 115V OR APPROVED EQ.
- 22 EJECTOR PIT



PROJECT NAME 304 THE STRAND - MAXWELL PROJECT NUMBER

23003 CLIENT

SCOTT MAXWELL PROJECT ADDRESS

304 THE STRAND MANHATTAN BEACH, CA 90266

#### ARCHITECT ANTHONY LANEY AIA LANEY LA, INC. 725 CYPRESS AVE HERMOSA BEACH CA 90254 (310) 870-7175 ÀNTHONY@LANEY.LA



MARK	DATE	DESCRIPTION
1	11/14/23	CDP 1
2	03/12/24	CDP 2 02
01 - WIP		Not in Transmittal Set
PROJECT NO: 23003		

PROJECT NO: 23003

MODEL FILE: 23003 - 304 The Strand - Maxwell

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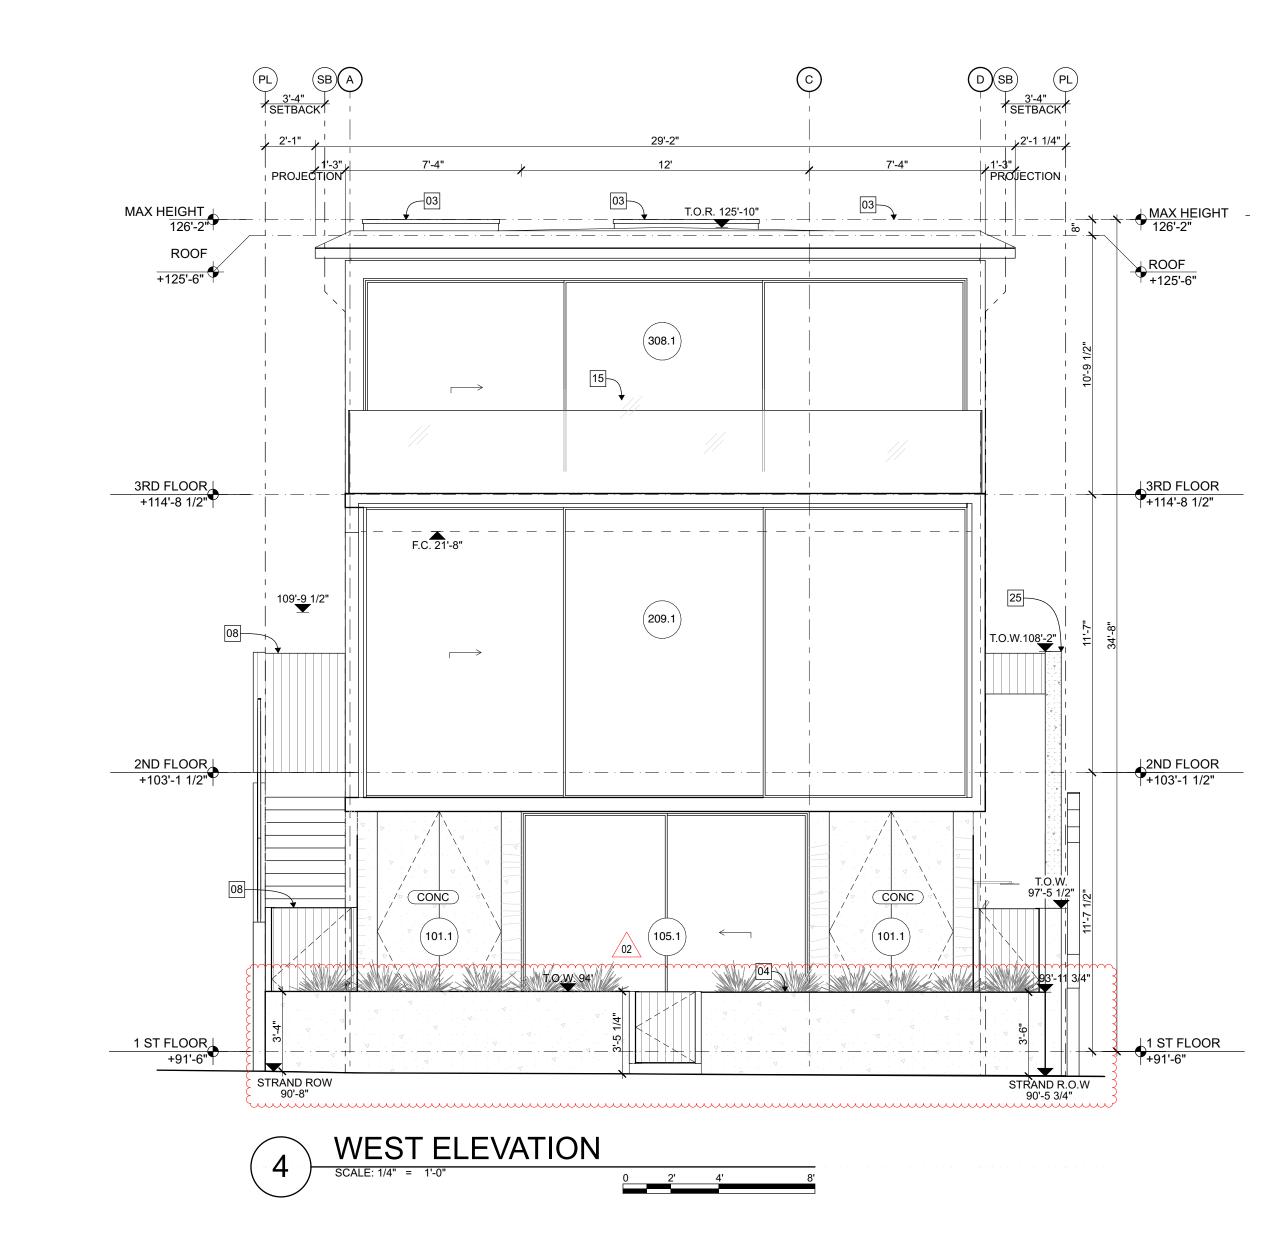
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## SHEET TITLE



A303

- W) PROVIDE UNDERGROUND ELECTRICAL AND COMMUNICATION SERVICE LATERALS PER CITY **ORDINANCE SECTION 9.12.050**
- () PARAPETS, SATELLITE ANTENNA, RAILS, SKYLIGHTS, ROOF EQUIPMENT MUST BE WITHIN THE HEIGHT LIMIT
- SOLAR PANELS: NEW HOUSE SHALL HAVE A SPARE RACEWAY FOR FUTURE SOLAR PANELS PER SOLAR CODE.
   PROVIDE UNDERGROUND ELECTRICAL AND COMMUNICATION SERVICE LATERALS PER CITY
   CONTRACTOR TO TRESHOLD DETAIL AND NOTIFY THE ARCHITECT BEFORE PROCEEDING WITH ANY NON-CONFORMING CONDITIONS.
  - L) EXTERIOR PAVING: IMPERVIOUS SURFACE SHALL BE SLOPED AWAY FROM THE BUILDING AT 2% MINIMUM SLOPE FOR A MINIMUM DISTANCE OF 10 FEE. LOT SHALL BE GRADED TO DRAIN SURFACE WATER AWAY FROM FOUNDATION WALLS PER CRC SECTION R401.3. ALL EXTERIOR PAVING SHALL BE SLOPED TO EITHER AREA DRAINS, THE STREET, OR ADJACENT PLANTING AREAS, DEPENDING ON THE LOCATION AND CONDITION. REFER TO CIVIL DRAWINGS FOR MORE INFORMATION.
  - M) PAVING JOINTS: CONTRACTOR TO VERIFY FINISH OF PAVING JOINTS FOR ALL EXTERIOR PAVING PRIOR TO PERFORMING ANY WORK. N) CONTROL JOINTS: CONTRACTOR TO VERIFY QUANTITY AND LOCATIONS OF CONTROL JOINTS FOR ALL EXTERIOR PAVING PRIOR TO PERFORMING ANY WORK.
  - O) SITE WALLS: CONTRACTOR TO VERIFY THAT ALL NEW YARD WALLS COMPLY WITH ZONING CODE HEIGHT LIMITATIONS.
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  - R) CURB CUTS AND SIDEWALKS: CONTRACTOR IS REQUIRED TO OBTAIN A SEPARATE PERMIT FOR ALL
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- 26 (E) SITE WALL
- 7 CONTOUR OF FLOOR ABOVE

## **KEYNOTES**

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PROJECT NAME 304 THE STRAND - MAXWELL PROJECT NUMBER

CLIENT SCOTT MAXWELL

23003

PROJECT ADDRESS 304 THE STRAND MANHATTAN BEACH, CA 90266

#### ARCHITECT ANTHONY LANEY AIA LANEY LA, INC. 725 CYPRESS AVE HERMOSA BEACH CA 90254 (310) 870-7175 ÀNTHONY@LANEY.LA



MARK	DATE	DESCRIPTION
1	11/14/23	CDP 1
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PROJECT NO: 23003		
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MODEL FILE: 23003 - 304 The Strand - Maxwe

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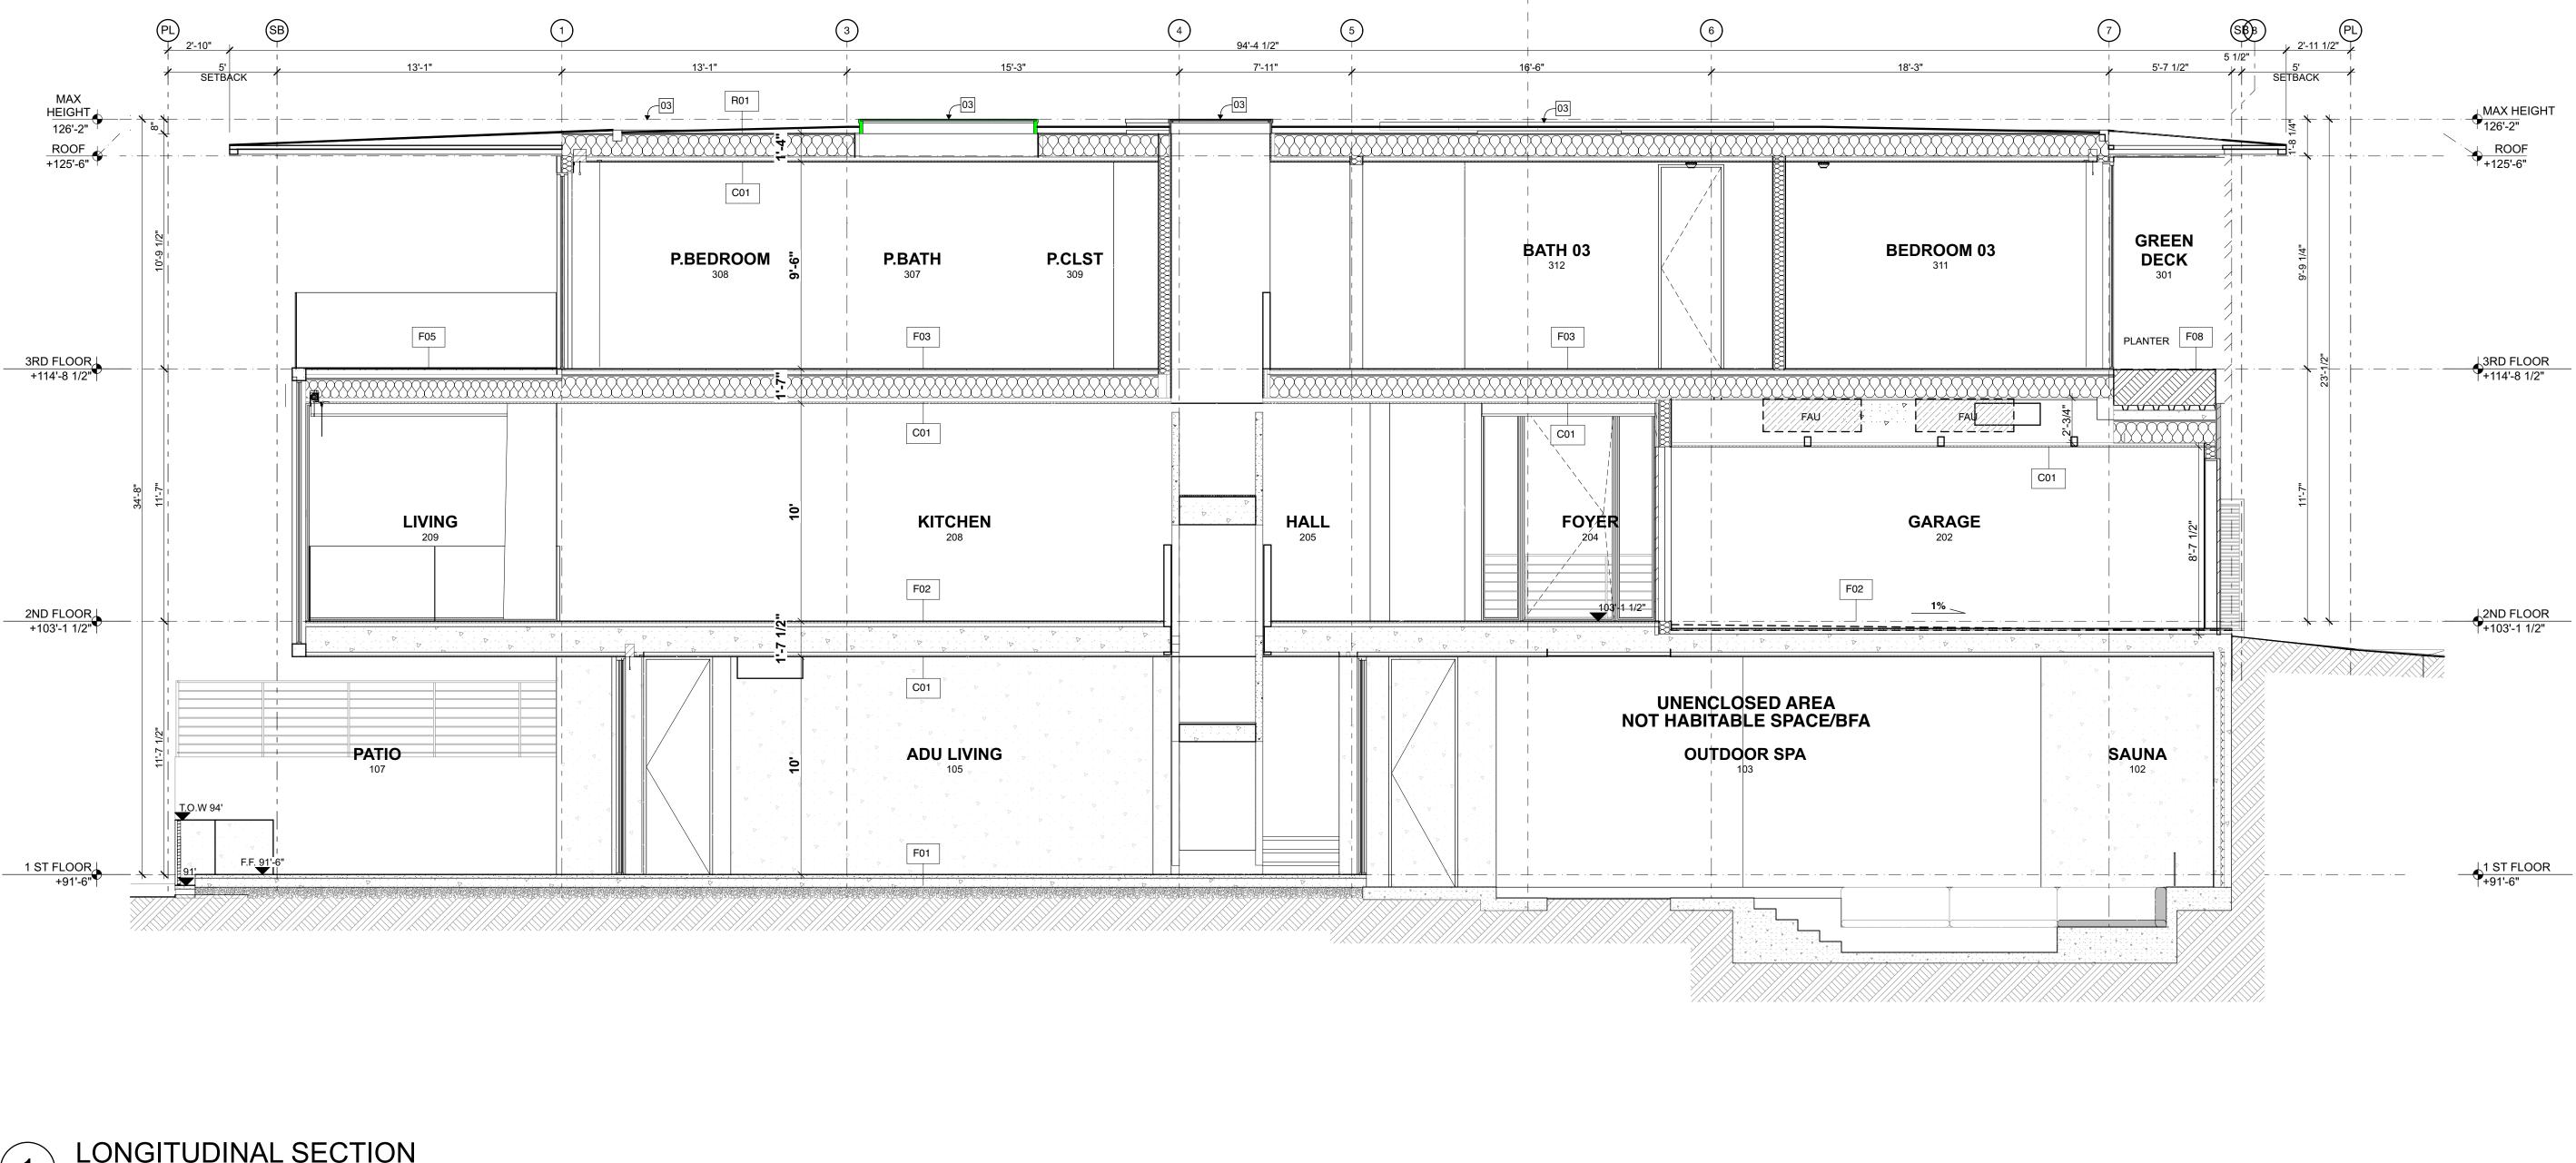
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SHEET TITLE





- SOLAR PANELS: NEW HOUSE SHALL HAVE A SPARE RACEWAY FOR FUTURE SOLAR PANELS PER SOLAR CODE.
   BOLVIDE UNDERCEDUND ELECTRICAL AND COMMUNICATION SERVICE LATERALS OF COLOR OF 1" BETWEEN THE TOP OF THRESHOLD AND TOP OF EXTERIOR FINISH SURFACE.
- W) PROVIDE UNDERGROUND ELECTRICAL AND COMMUNICATION SERVICE LATERALS PER CITY **ORDINANCE SECTION 9.12.050**
- ) PARAPETS, SATELLITE ANTENNA, RAILS, SKYLIGHTS, ROOF EQUIPMENT MUST BE WITHIN THE HEIGHT LIMIT
- O REFER TO THRESHOLD DETAIL AND NOTIFY THE ARCHITECT BEFORE PROCEEDING CONTRACTOR T WITH ANY NON-CONFORMING CONDITIONS.
- L) EXTERIOR PAVING: IMPERVIOUS SURFACE SHALL BE SLOPED AWAY FROM THE BUILDING AT 2% MINIMUM SLOPE FOR A MINIMUM DISTANCE OF 10 FEE. LOT SHALL BE GRADED TO DRAIN SURFACE WATER AWAY FROM FOUNDATION WALLS PER CRC SECTION R401.3. ALL EXTERIOR PAVING SHALL BE SLOPED TO EITHER AREA DRAINS, THE STREET, OR ADJACENT PLANTING AREAS, DEPENDING ON THE LOCATION AND CONDITION. REFER TO CIVIL DRAWINGS FOR MORE INFORMATION.
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- P) EXTERIOR WALLS: ALL EXTERIOR WALLS LOCATED WITHIN 5' OF PROPERTY LINES SHALL BE ONE-HOUR FIRE RATED PER CRC TABLE R302.1 (
- **Q) FENCE/WALL/HANDRAIL/HEDGE HEIGHTS:** CONTRACTOR TO MEET ALL STATE AND LOCAL CODE REQUIREMENTS FOR SUCH STRUCTURES. REFER TO SITE PLAN FOR DRIVEWAY VISIBILITY REQUIREMENTS. HEIHTS TO BE MEASURED FROM THE LOWEST FINISHED ADJACENT GRADE. R) CURB CUTS AND SIDEWALKS: CONTRACTOR IS REQUIRED TO OBTAIN A SEPARATE PERMIT FOR ALL
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- T) DRIVEWAY PROFILES: DRIVEWAY PROFILES EXCEEDING 10% GRADE SHALL BE STAKED AND VERIFIED BY LICENSED PROFESSIONAL LAND SURVEYOR PRIOR TO POURING THE GARAGE SLAB. DRIVEWAY GRADES EXCEEDING 15% ARE NOT PERMITTED.
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LONGITUDINAL SECTION

A) SETBACKS: CONTRACTOR SHALL VERIFY THAT ALL CODE REQUIRED SETBACKS AND HEIGHT 23 POOL VAULT LIMITATIONS ARE OBSERVED. REFER TO ZONING DIAGRAMS FOR MORE INFORMATION. B) EXCAVATIONS, BACKFILL, AND COMPACTION REQUIREMENTS: CONTRACTOR SHALL COMPLY WITH ALL REQUIREMENTS OF THE GEOTECHNICAL ENGINEERING REPORT, SOILS REPORT AND/OR SHORING ENGINEERING, FOR ALL EXCAVATIONS, BACKFILL, AND COMPACTION 5 (N) RETAINING WALL 26 (E) SITE WALL C) SHORING: IF REQUIRED, SHORING IS TO BE UNDER SEPARATE PERMIT PREPARED BY STRUCTURAL ENGINEER PRIOR TO CONSTRUCTION. CONTOUR OF FLOOR ABOVE ) PROTECTION OF EXISTING PLANTING AND TRESS: ALL EXISTING PLANT MATERIAL AND TREES NOT 28 DRIVEWAY VISIBILITY TRIANGLE INDICATED TO BE REMOVED SHALL BE PROTECTED TO THE DRIP-LINE DURING DEMOLITION AND CONSTRUCTION. ANY PLANTING OR TREES THAT ARE DAMAGED OR KILLED SHALL BE REPLACED BY THE CONTRACTOR AT NO COST TO THE OWNER. E) PROTECTION OF EXISTING STRUCTURES: ALL EXISTING STRUCTURES NOT INDICATED TO BE REMOVED SHALL BE PROTECTED DURING DEMOLITION AND CONSTRUCTION. ANY FINISHES THAT ARE REMOVED OR OTHERWISE DAMAGED SHALL BE REPLACED BY THE CONTRACTOR AT NO COST TO THE OWNER. ) STORM DRAINAGE/SUSMP REQUIREMENTS: CONTRACTOR SHALL VERIFY WITH GOVERNING AGENCIES IF A STANDARD URBAN STORMWATER MITIGATION PLAN (SUSMP) OR OTHER POLLUTION PREVENTION FILTERING SYSTEM IS REQUIRED. ALL DOWNSPOUTS AND AREA DRAINS SHALL CONNECT INTO PVC DRAINAGE PIPES THAT TERMINATE AT THE SUSMP OR TO THE STREET AS REQUIRED. G) SEWER CLEAN-OUTS: CONTRACTOR TO COORDINATE LOCATION OF ALL SEWER CLEAN-OUTS WITH ARCHITECT PRIOR TO PERFORMING ANY WORK. I) UTILITIES: CONTRACTOR SHALL COORDINATE LOCATION OF ALL NEW UTILITY CONNECTION POINTS AND METERS. CONTRACTOR SHALL PROTECT ALL EXISTING UTILITY SUPPLIES, CONNECTION POINTS AND METERS FROM DAMAGE.

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ALUMINIUM DOWNSPOUT, 4", CAST FASCIA BRACKETS, COLOR TO BE APPROVED BY ARCHITECT

## **KEYNOTES**

- 01 DRAIN PER CIVIL. 02 GUTTER 03 SKYLIGHT 04 PLANTER 05 ROOF CONTOUR ABOVE 06 SOLAR ARRAY 07 NEIGHBORING SITE WALL 08 GATE 09 HOSE BIB 10 FOOT WASH
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22 EJECTOR PIT


	PROJECT NAME 304 THE STRAND - MAXWELL PROJECT NUMBER 23003 CLIENT SCOTT MAXWELL PROJECT ADDRESS 304 THE STRAND MANHATTAN BEACH, CA 90266		
	ARCHITECT ANTHONY LANEY AIA LANEY LA, INC. 725 CYPRESS AVE HERMOSA BEACH CA 90254 (310) 870-7175 ANTHONY@LANEY.LA		
ľ	MARK	DATE	DESCRIPTION
	1 2	11/14/23 03/12/24	CDP 1 CDP 2
	01 - WIP		Not in Transmittal Set
	PROJECT NO: 23003 MODEL FILE: 23003 - 304 The Strand - Maxwell DRAWN BY: JS/BJ COPYRIGHT: SHEET TITLE BUILDING SECTIONS		
		A	401

- W) PROVIDE UNDERGROUND ELECTRICAL AND COMMUNICATION SERVICE LATERALS PER CITY
- ) PARAPETS, SATELLITE ANTENNA, RAILS, SKYLIGHTS, ROOF EQUIPMENT MUST BE

**ORDINANCE SECTION 9.12.050** 

WITHIN THE HEIGHT LIMIT

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- AC CONDENSER HEAT PUMPS PER T24.
- 15 GLASS RAILING; 42" MIN. HIGH
- 16 RECYCLE/TRASH BINS. 17 42" MIN. HIGH GUARDRAIL
- 18 OUTDOOR STORAGE
- 19 SLIDING SCREEN ACCESS
- [20] GAS RANGE WITH OVERHEAD HOOD.
- 21 SUMP PUMP ATUO PUMP 115V OR APPROVED EQ.
- 22 EJECTOR PIT

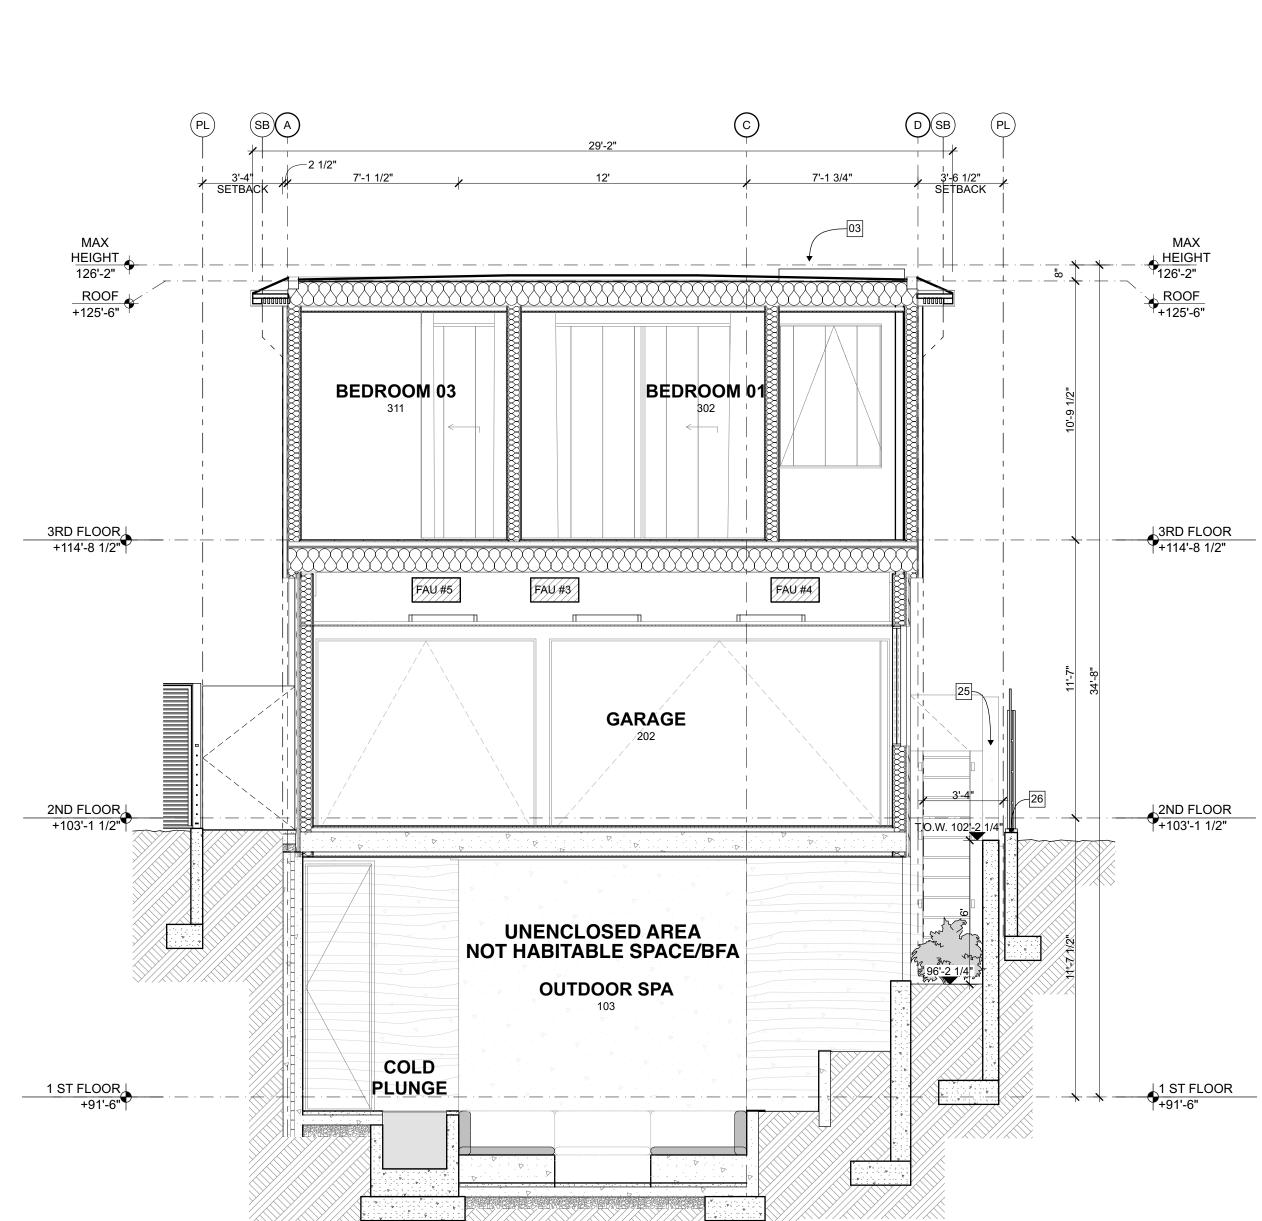

PROJECT NAME 304 THE STRAND - MAXWELL **PROJECT NUMBER** 

23003 CLIENT SCOTT MAXWELL

PROJECT ADDRESS 304 THE STRAND MANHATTAN BEACH, CA 90266

#### ARCHITECT ANTHONY LANEY AIA LANEY LA, INC. 725 CYPRESS AVE HERMOSA BEACH CA 90254 (310) 870-7175 ÀNTHONY@LANEY.LA



MARK	DATE	DESCRIPTION
1	11/14/23	CDP 1
2	03/12/24	CDP 2
01 - WIP		Not in Transmittal Set

PROJECT NO: 23003

MODEL FILE: 23003 - 304 The Strand - Maxwell

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## SHEET TITLE

BUILDING SECTIONS

